City of Syracuse Office of Zoning Administration

ANTENNA / TOWER / SATELLITE DISH APPLICATION

City Hall Commons - Room 500 * 201 E. Washington Street * Syracuse, NY 13202-1426 315-448-8640 * zoning@syrgov.net * www.syrgov.net/Zoning.aspx

	ling Date: 11/4	1/21 Case	: 5R-03-071	13 Zoning	District:	B		
REQUESTE	ED (Check ap	, plicable and briefly	y describe.)					
Type		posed or ograded						
Antenna:	Upgr	aded Mod	dification to Exist	ing Cell Tov	wer Equipm	ent		
☐ Tower:								
☐ Satellite ☐	Dish:							
TAX ASSES	SSMENT A	DDRESS(ES)	TAX MAP I	0)		NER(S)	_	DATE QUIRED
1) 1654 W C	Onondaga St	reet	09102-32.1		tholic Char Mobile, Te		110	Venter
2)	3				WODIIO, TO	ilaitij		
3)			-					
4)								
-	Department o	f Assessment prope	erty tax records at	http://svrgo	v.net/Assess	ment.aspx -	315-448-8280.	
		G APPLICAT						
es bdivision	pecial ermi	t ro ect ite evi	e etc.)	retated City	oning upp	nications y	аррисавіе е.g.	
1)		2)				3)		
PROJECT I	DESCRIPT	ION (rovide a b	orief description of	the pro ect	incl ding ar	nd p rpose o	r need and st	ification.)
Modification to	Existing Ce	II Tower Equipme	ent (see attached	sheet for p	roject scop	e of work)		
-								
ANTENNA								
							D-1111	4.0.4
Proposed or	Installation	n Antenn	a Support Struct	ure	Total	Total		nstallations
Proposed or Upgrading	Installation (building o		a Support Struct	ure	Total Number	Total Antenna	Building I Base Antenna	nstallations Maximum Antenna
Proposed or Upgrading	Installation (building of tower)			ure			Base Antenna	Maximum
	(building o		Construction	ure	Number	Antenna Structure Height	Base Antenna Height Above	Maximum Antenna Height Above
	(building o		Construction	ure	Number of	Antenna Structure	Base Antenna Height Above Grade	Maximum Antenna Height Above Roof Line
Upgrading	(building o tower)		Construction	ure	Number of Antennas	Antenna Structure Height (feet)	Base Antenna Height Above Grade (feet)	Maximum Antenna Height Above Roof Line (feet)
Upgrading Upgrading	(building o		Construction	ure	Number of	Antenna Structure Height	Base Antenna Height Above Grade	Maximum Antenna Height Above Roof Line
Upgrading Upgrading TOWER	(building o tower) Building	r	Construction (describe)		Number of Antennas	Antenna Structure Height (feet)	Base Antenna Height Above Grade (feet) 80 feet	Maximum Antenna Height Above Roof Line (feet) See CDs
Upgrading Upgrading	(building o tower)		Construction (describe)	ure Minimum Distance	Number of Antennas 6	Antenna Structure Height (feet)	Base Antenna Height Above Grade (feet)	Maximum Antenna Height Above Roof Line (feet) See CDs
Upgrading Upgrading TOWER Proposed	(building o tower) Building Number	Construction Ty	Construction (describe)	Minimun Distance t Property Boundary	Number of Antennas	Antenna Structure Height (feet)	Base Antenna Height Above Grade (feet) 80 feet	Maximum Antenna Height Above Roof Line (feet) See CDs quipment / ad / Building
Upgrading TOWER Proposed or	(building of tower) Building Number of Service	Construction Ty (monopole, lattic work, guyed	Construction (describe) pe Maximum Construction (describe)	Minimum Distance of Property	Number of Antennas	Antenna Structure Height (feet)	Base Antenna Height Above Grade (feet) 80 feet Accessory E Enclosure / Pa	Maximum Antenna Height Above Roof Line (feet) See CDs quipment / ad / Building
Upgrading TOWER Proposed or Upgrading	Building Number of Service Providers	Construction Ty (monopole, lattic work, guyed	Construction (describe) pe Maximum Construction (describe)	Minimun Distance t Property Boundary	Number of Antennas	Antenna Structure Height (feet)	Base Antenna Height Above Grade (feet) 80 feet Accessory E Enclosure / Pa	Maximum Antenna Height Above Roof Line (feet) See CDs quipment / ad / Building
Upgrading TOWER Proposed or	Building Number of Service Providers	Construction Ty (monopole, latti- work, guyed support, etc.)	Construction (describe) pe Maximum Construction (describe)	Minimum Distance of Property Boundar (feet)	Number of Antennas	Antenna Structure Height (feet) 83 feet	Base Antenna Height Above Grade (feet) 80 feet Accessory E Enclosure / Pa	Maximum Antenna Height Above Roof Line (feet) See CDs quipment / ad / Building
Upgrading TOWER Proposed or Upgrading SATELLITE	Building Number of Service Providers	Construction Ty (monopole, latti- work, guyed support, etc.)	ce Maximum Tower Height (feet)	Minimum Distance t Property Boundar (feet)	Number of Antennas 6 Color to y Distance Street	Antenna Structure Height (feet) 83 feet Lighting	Base Antenna Height Above Grade (feet) 80 feet Accessory E Enclosure / Pa (type and so	Maximum Antenna Height Above Roof Line (feet) See CDs quipment / ad / Building
Upgrading TOWER Proposed or Upgrading SATELLITE Proposed or	Building	Construction Ty (monopole, latti- work, guyed support, etc.)	ce Maximum Tower Height (feet)	Minimum Distance t Property Boundar (feet)	Number of Antennas 6 Color to y Distance	Antenna Structure Height (feet) 83 feet Lighting	Base Antenna Height Above Grade (feet) 80 feet Accessory E Enclosure / Pa (type and so	Maximum Antenna Height Above Roof Line (feet) See CDs quipment / ad / Building

PROPERTY OWNER(S) (required)

As listed in Department of Assessment property tax records (http://syrgov.net/Assessment.aspx - 315-448-8280). If not listed as the owner, please provide proof of ownership, e.g., a copy of the deed. Attorney's signing on behalf of the owner must include a letter describing the legal arrangement. If the property owner is a Corporation or Organization, the person signing must provide member verification. Contract purchasers, tenants, architects, engineers, contractors, etc. CANNOT sign on behalf of the owner.

Cullen	Morgan	Agent of Owner	Cath	olic Charitie	es
First Name	Last Name	Title	Com	pany	
1654 W Onondaga	Street	Syracuse	NY	13204	Phone: (941)-549-7263
Street Address	Apt / Suite / Other	City	St	Zip	Email: cmorgan@clinellc.com
* Signature:	Jon		Date	: 11/01/2	021
First Name	Last Name	Title	Com	pany	
					Phone:
Street Address	Apt / Suite / Other	City	St	Zip	Email:
* Signature:			Date	:	
First Name	Last Name	Title	Com	pany	
					Phone:
Street Address	Apt / Suite / Other	City	St	Zip	Email:
* Signature:			Date	:	
First Name	Last Name	Title	Com	pany	
					Phone:
Street Address	Apt / Suite / Other	City	St	Zip	Email:
* Signature:	pės Pipulitytaisis		Date	:	

* OWNER SIGNATURE DECLARATION

I understand that false statements made herein are punishable as a Class A Misdemeanor, pursuant to section 210.45 of the Penal Law of the State of New York. I declare that, subject to the penalties of perjury, any statements made on this application and any attachments are the truth and to the best of my knowledge correct. I also understand that any false statements and/or attachments presented knowingly in connection with this application will be considered null and void.

APPLICANT(S) (if applicable)

		Tenant	T-Mo	bile Northe	east, LLC
First Name	Last Name	Title	Comp	pany	
103 Monarch Drive		Liverpool	NY	13088	Phone: (941)-549-7263
Street Address	Apt / Suite / Other	City	St	Zip	Email: cmorgan@clinellc.com
First Name	Last Name	Title	Com	pany	
					Phone:
Street Address	Apt / Suite / Other	City	St	Zip	Email:
REPRESENTATIVE(S)/CONTACT(S) ((if applicable)			
Cullen	Morgan S	ite Acquisition Consultant	Cent	terline Com	munications LLC - Agent for T-Mobile
First Name	Last Name	Title	Com	pany	
12579 Sagewood Drive		Venice	FL	34293	Phone: (941)-549-7263
Street Address	Apt / Suite / Other	City	St	Zip	Email: cmorgan@clinellc.com
Kelley	Cross	Program Manager	Cen	terline Com	munications LLC - Agent for T-Mobile
First Name	Last Name	Title	Com	pany	
1521 Tracy Drive	6	Skaneatles	NY	13152	Phone: (657)-237-9590
Street Address	Apt / Suite / Other	City	St	Zip	Email: kcross@clinellc.com



November 1, 2021

ATTN: Heather Lamendola, Zoning Administrator City of Syracuse Zoning Office 201 E Washington Street Room 500 Syracuse, NY 13202

RE: 1654 W Onondaga Street, Syracuse, NY / T-Mobile Site: 3ONS220B – EQUIPMENT UPGRADE // Planning Commission Review

Dear Ms. Lamendola,

Please find the completed Planning Board application along with CDs and the SEQRA form for the above-mentioned T-Mobile upgrade project. Also, included is a redacted portion of the lease demonstrating that T-Mobile, as successor in interest to Omnipoint Communications Inc, is a tenant and has the right to apply for the Planning Board Review.

Please put this project on the next Planning Commission Board meeting agenda, and please do not hesitate to contact me via phone at (941)-549-7263 with any questions.

Thank you,

Cullen Morgan, Site Acquisition Consultant

Centerline Communications, LLC (agent for T-Mobile)

cmorgan@clinellc.com

(941)-549-7263

PROPOSED SCOPE OF WORK FOR 3ONS220B

THE PROPOSED PROJECT INCLUDES MODIFYING EQUIPMENT AS INDICATED PER BELOW:

- Swap (6) existing antennas for (6) proposed antennas
- Remove (1) antenna, mount and ancillary equipment
- Add (6) RRUs
- 200A Electrical Upgrade




SITE NAME

WESTERN LIGHTS

SITE I.D. NUMBER 3ONS220B

67E5A998E PBC6200+P6230

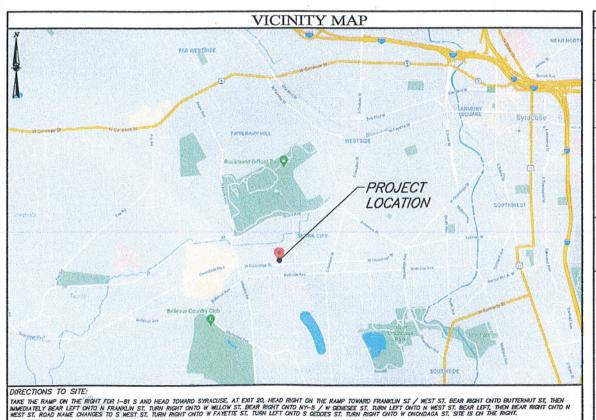

Dig Safely. New York

PROJECT INFORMATION 1. PROJECT ADDRESS: 1654 WEST OF 2. PARCEL ID: 091.0-02-032.1 3. ZONING JURISDICTION: CITY OF SY 4. ZONING DISTRICT: (RB) RESIDENTIA	RACUSE		04		
FACILITY INFORMATION FACILITY TYPE: ROOFTOP PROPOSED USE: UNATTENDED TELECT FACILITY: (1-2) VISITS PER MONTH E		BUILDING LOC LAT: 43° 02 LONG: -76° 10 GROUND ELEV	02.6" (054.3"	(43.03406 (-76.1817	000°) 74000°)
UPGRADE 100A ELECTRIC SERVICE TO 200A, AD 4813 & (1) NRs ROUTER TO 19" RACK, ADO CASLES. SWAP (3) AIR32 ANTENIAS WITH (3) A (3) RADIO 4480S AND ADD (3) RADIO 4460 B2	(3) INDOOR SPD BOXES, S VR6449 ANTENNAS, SWAP	SWAP EXISTING COAX C. (3) AIR21 ANTENNAS W	ABLES WITH	(3) 6x24 F	MBRID
REFERENCES 1. ONONDAGA COUNTY GIS MAPPING. 2. DESIGN DRAWINGS BY INFINICY ON 3. RFDS SHEET DATED 7/27/21.	6/28/18.				
APPROVAL BLOCK			APPROVED	APPROVED AS NOTED	DISAPPROVED
PROPERTY OWNER					
	DATE				
SITE ACQUISITION	DATE	-			
SITE ACQUISITION CONSTRUCTION MANAGER					
	DATE				

PROJECT INDEX

	(CONSULTANT TEA	M			
		PROJECT DIRECTORY				
BUILDING ADDRESS	OWNER:	CATHOLIC CHARITIES 1654 ONONDAGA STREET SYRACUSE, NY 13204	CONTACT: TELE.:			
APPLICAN ADDRESS		T-MOBILE NORTHEAST, LLC 103 MONARCH DRIVE LIVERPOOL, NY 13088	CONTACT: TELE.:	PETER E (315) 26		
PROJECT ADDRESS	ROJECT MANAGER: CENTERLINE COMMUNICATIONS DDRESS: 750 W. CENTER STREET, SUITE 301 WEST BRIDGEWATER, MA 02379 TELE.: (657) 2				ELLEY CROSS 557) 237-9590	
CIVIL ENG ADDRESS	DDDECC. 17 INDUCTORAL CODET		CONTACT: TELE.:	DON CARPENTER (585)-370-9516		
		SHEET INDE	EX			
SHEET NO.		DESCRIPTION		REV. NO.	REV. DATE	
T-1	TITLE SI	HEET		2	10/26/21	
C-1	SITE PLAN				10/26/21	
C-2	ELEVATION				10/26/21	
C-3	ANTENNA PLAN & SCHEDULE				10/26/21	
C-4					10/26/21	
		LAYOUT & DETAILS		2	10/26/21	
C-5				2	10/26/21	
C-5 C-6	SITE DE					
C-5 C-6 E-1	ELECTRI	CAL PLAN A		2	10/26/21	
C-5 C-6	ELECTRI ELECTRI					

REQUIRED MODIFICATION DRAWINGS PREPARED BY ALBUL ENGINEERING




T-Mobile Northeast, LLC 103 Monarch Drive Liverpool, NY 13088 (315) 453-1340



750 W. Center Street, Suite 301 West Bridgewater, MA 02379 PHONE: (844) 748-8878



DESIGNED BY: DRB	DATE: 9/27/21
APPROVED BY: DWC	PROJECT NO: 21-CL-081

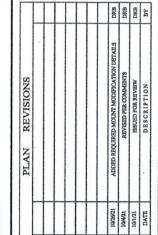



SITE INFORMATION
SITE I.D.# NUMBER:
3ONS220B
SITE NAME:
WESTERN LIGHTS


SITE ADDRESS: 1654 W. ONONDAGA STREET SYRACUSE, NY 13204 SITE TYPE: ROOFTOP


SHEET TITLE

TITLE SHEET

SHEET NUMBER

T-1

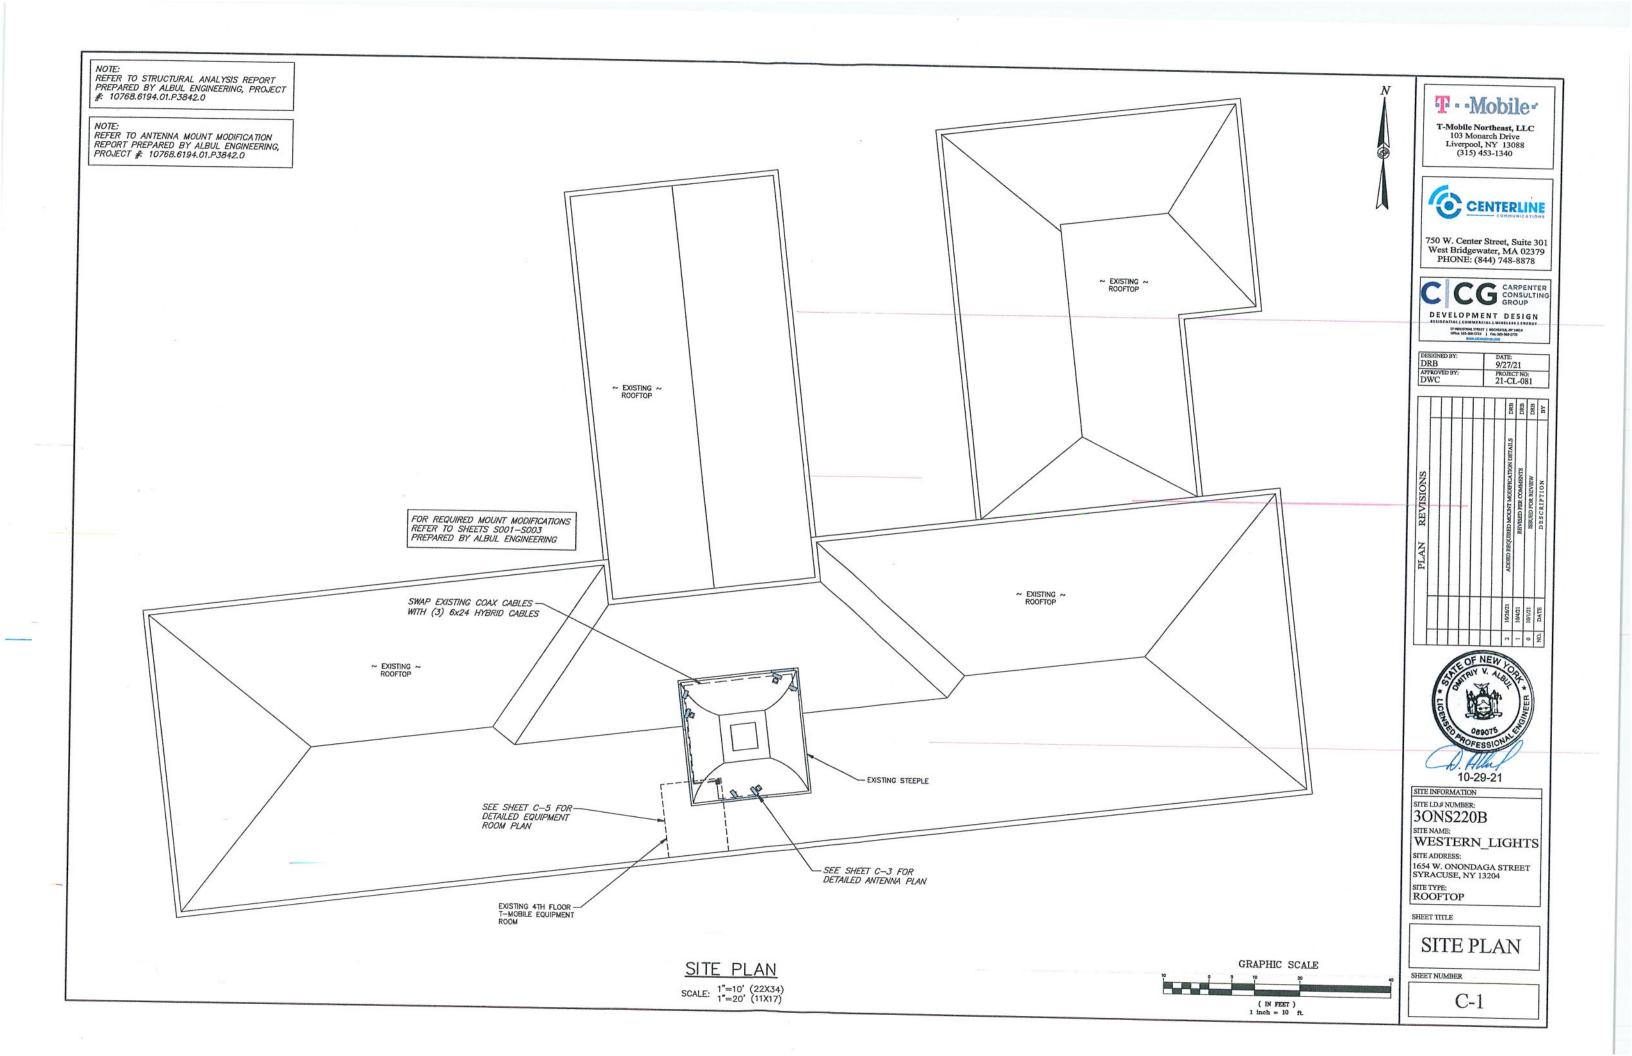

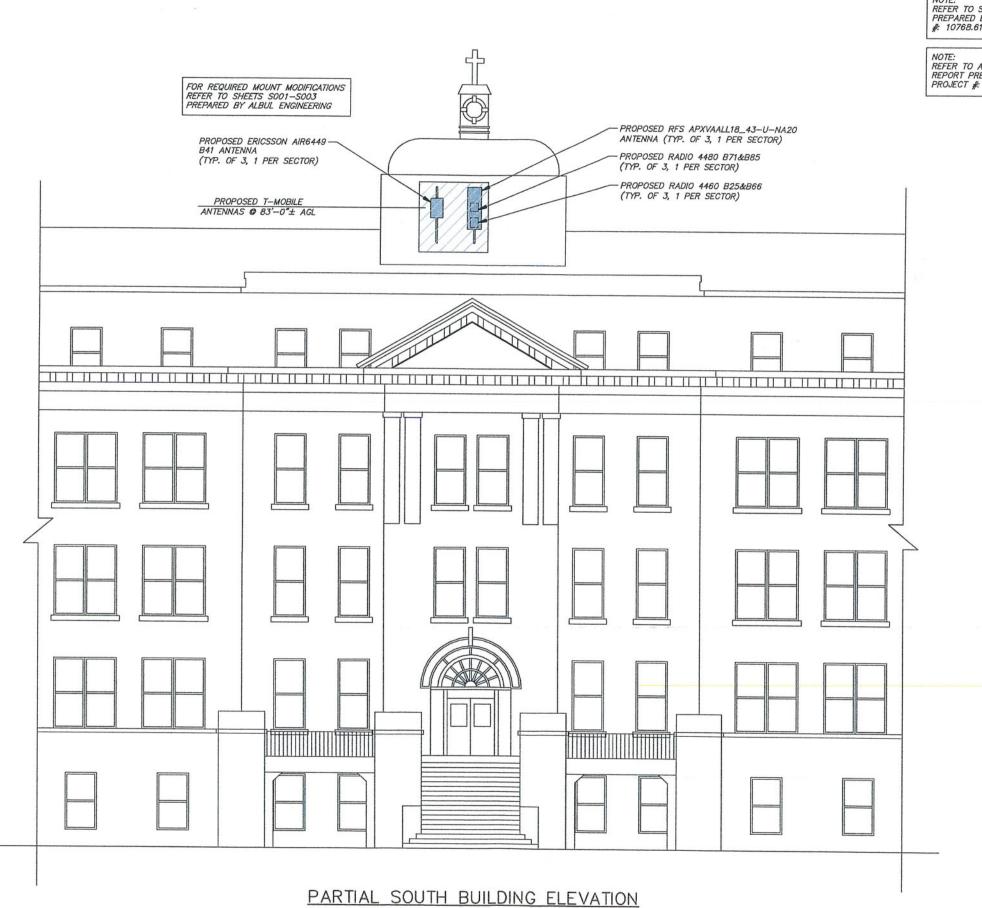

REFER TO STRUCTURAL ANALYSIS REPORT PREPARED BY ALBUL ENGINEERING, PROJECT #: 10768.6194.01.P3842.0

REFER TO ANTENNA MOUNT MODIFICATION REPORT PREPARED BY ALBUL ENGINEERING, PROJECT #: 10768.6194.01.P3842.0



T-Mobile Northeast, LLC 103 Monarch Drive Liverpool, NY 13088 (315) 453-1340



750 W. Center Street, Suite 301 West Bridgewater, MA 02379 PHONE: (844) 748-8878



DEVELOPMENT DESIGN

ET INDUSTRIAL STREET | ROCHESTER, MY 1462A Office: 365-360-2733 | Fait 563-360-2735 DESIGNED BY: DRB APPROVED BY: DWC DATE: 9/27/21 PROJECT NO: 21-CL-081

	DRB	DRB	DRB	BY
PLAN REVISIONS	ADDED REQUIRED MOUNT MODIFICATION DETAILS	REVISED PER COMMENTS	ISSUED FOR REVIEW	DESCRIPTION
	102621	10/4/21	10/1/21	DATE



SITE INFORMATION SITE LD.# NUMBER:

30NS220B

SITE NAME: WESTERN_LIGHTS


SITE ADDRESS: 1654 W. ONONDAGA STREET SYRACUSE, NY 13204 SITE TYPE: ROOFTOP


SHEET TITLE

ELEVATION

SHEET NUMBER

C-2

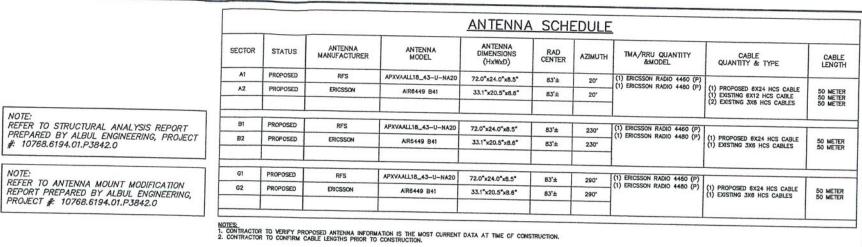

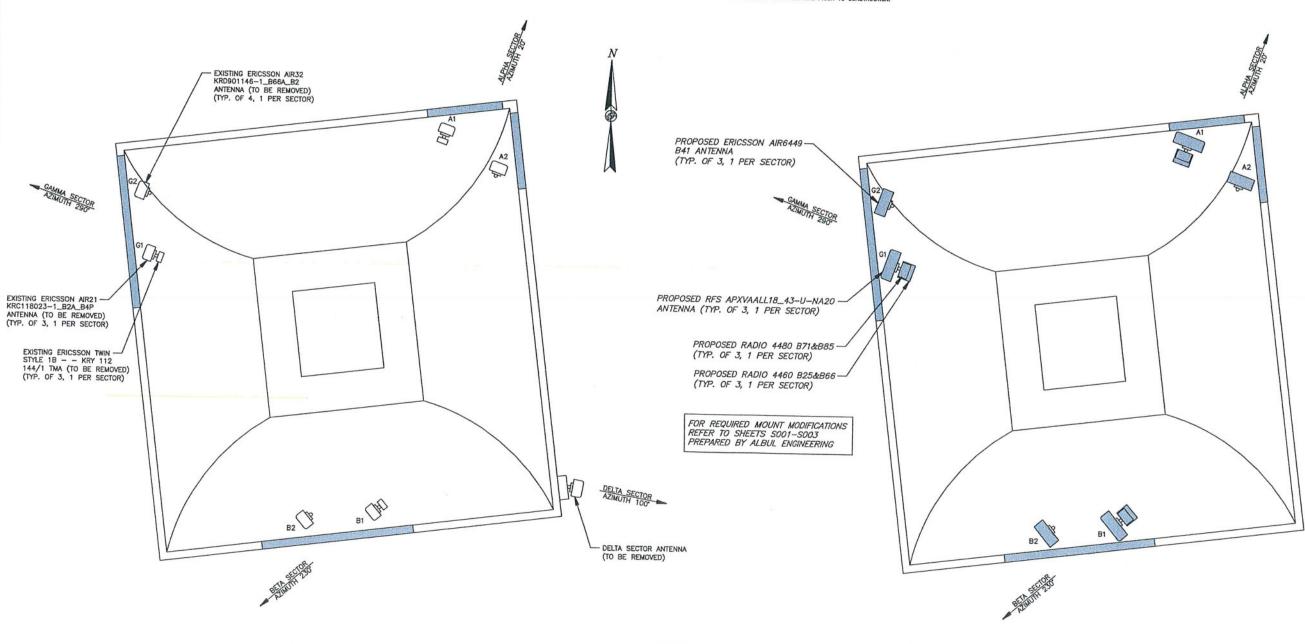

GRAPHIC SCALE

(IN FEET) 1 inch = 3 ft.

EXISTING ANTENNA PLAN

SCALE: 1"=3' (22X34) 1"=6' (11X17) PROPOSED ANTENNA PLAN

SCALE: 1"=3' (22X34) 1"=6' (11X17)



T-Mobile Northeast, LLC 103 Monarch Drive Liverpool, NY 13088 (315) 453-1340



750 W. Center Street, Suite 301 West Bridgewater, MA 02379 PHONE: (844) 748-8878



17 INCRESTOR, STREET | INCRESTOR NY 14444 COIGN 195-196-2721 | 7-06-305-306-2738 BYOLD ADMINISTRAÇÃO DESIGNED BY: DATE:

DESIGNED BY:	DATE: 9/27/21
APPROVED BY:	PROJECT NO:
DWC	21-CL-081





SITE INFORMATION
SITE I.D.# NUMBER:
3ONS220B

WESTERN_LIGHTS


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SHEET TITLE


ANTENNA PLAN & SCHEDULE


SHEET NUMBER

C-3

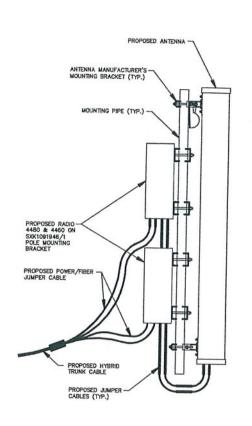


RFS MOUNTING DETAIL N.T.S.

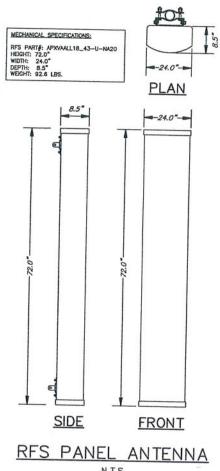

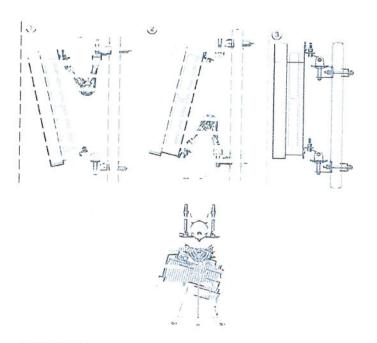



ERICSSON AIR 6449 MOUNTING DETAIL

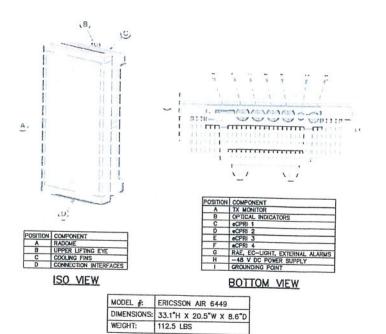

ERICSSON AIR 6449 DETAIL

N.T.S.

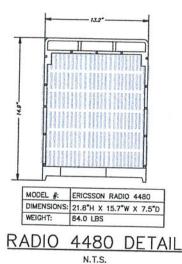


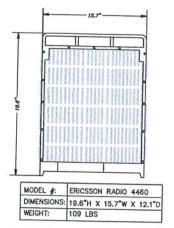

RADIO 4460 DETAIL N.T.S.

NOIE:
REFER TO STRUCTURAL ANALYSIS REPORT
PREPARED BY ALBUL ENGINEERING, PROJECT
#: 10768.6194.01.P3842.0

NOTE:
REFER TO ANTENNA MOUNT MODIFICATION
REPORT PREPARED BY ALBUL ENGINEERING,
PROJECT #: 10768.6194.01.P3842.0

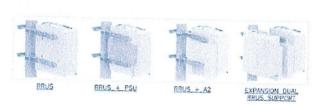

CLAMP MOUNTING RANGE	TUBES	SQUARE PROFILES	90' ANGLE
MINIMUM	#25 mm (1,0 in)	35 x 35 mm (1.4 x 1,4 in)	35 x 35 mm (1,4 x 1,4 in)
махімим	#114 mm (4,5 in)	$80 \times 80 \text{ mm}$ (3.2 × 3.2 in)	80 × 80 mm (3,2 × 3,2 in)

HOT DIP GALVANIZED STEEL BRACKET MATERIAL S35SMC FZV, FASTENERS 8.8 FZV OR EDUVALENT MRIMUM 70 UM ZINC COADNO, DESIGNED FOR >20 YEARS CORROSION-FREE DESIGNED TO 67 M/S WIND SPEED REQUIREMENT (150 MPH)

SUPPORTS RRUW/RRUSO1, RRUS11/12. RRUS32 WITH RRUSA2 OR PSU SXK1091946/1 FOR FIRST RRUS & SXK109146/2 TO ADD SECOND RRUS

SXK1091946/1 SIDE MOUNT DETAIL
N.T.S.

T · · Mobile ·


T-Mobile Northeast, LLC 103 Monarch Drive Liverpool, NY 13088 (315) 453-1340



750 W. Center Street, Suite 301 West Bridgewater, MA 02379 PHONE: (844) 748-8878



17 MOUSTRAL STREET | ROCHESTER, NY 14614 Office: 585-360-2738 | Fai: 583-360-2739 DESIGNED BY:
DRB
APPROVED BY: DATE: 9/27/21

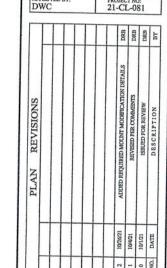



10-29-21 SITE INFORMATION

SITE LD.# NUMBER: 30NS220B SITE NAME:
WESTERN_LIGHTS


SITE ADDRESS: 1654 W. ONONDAGA STREET SYRACUSE, NY 13204 SITE TYPE: ROOFTOP


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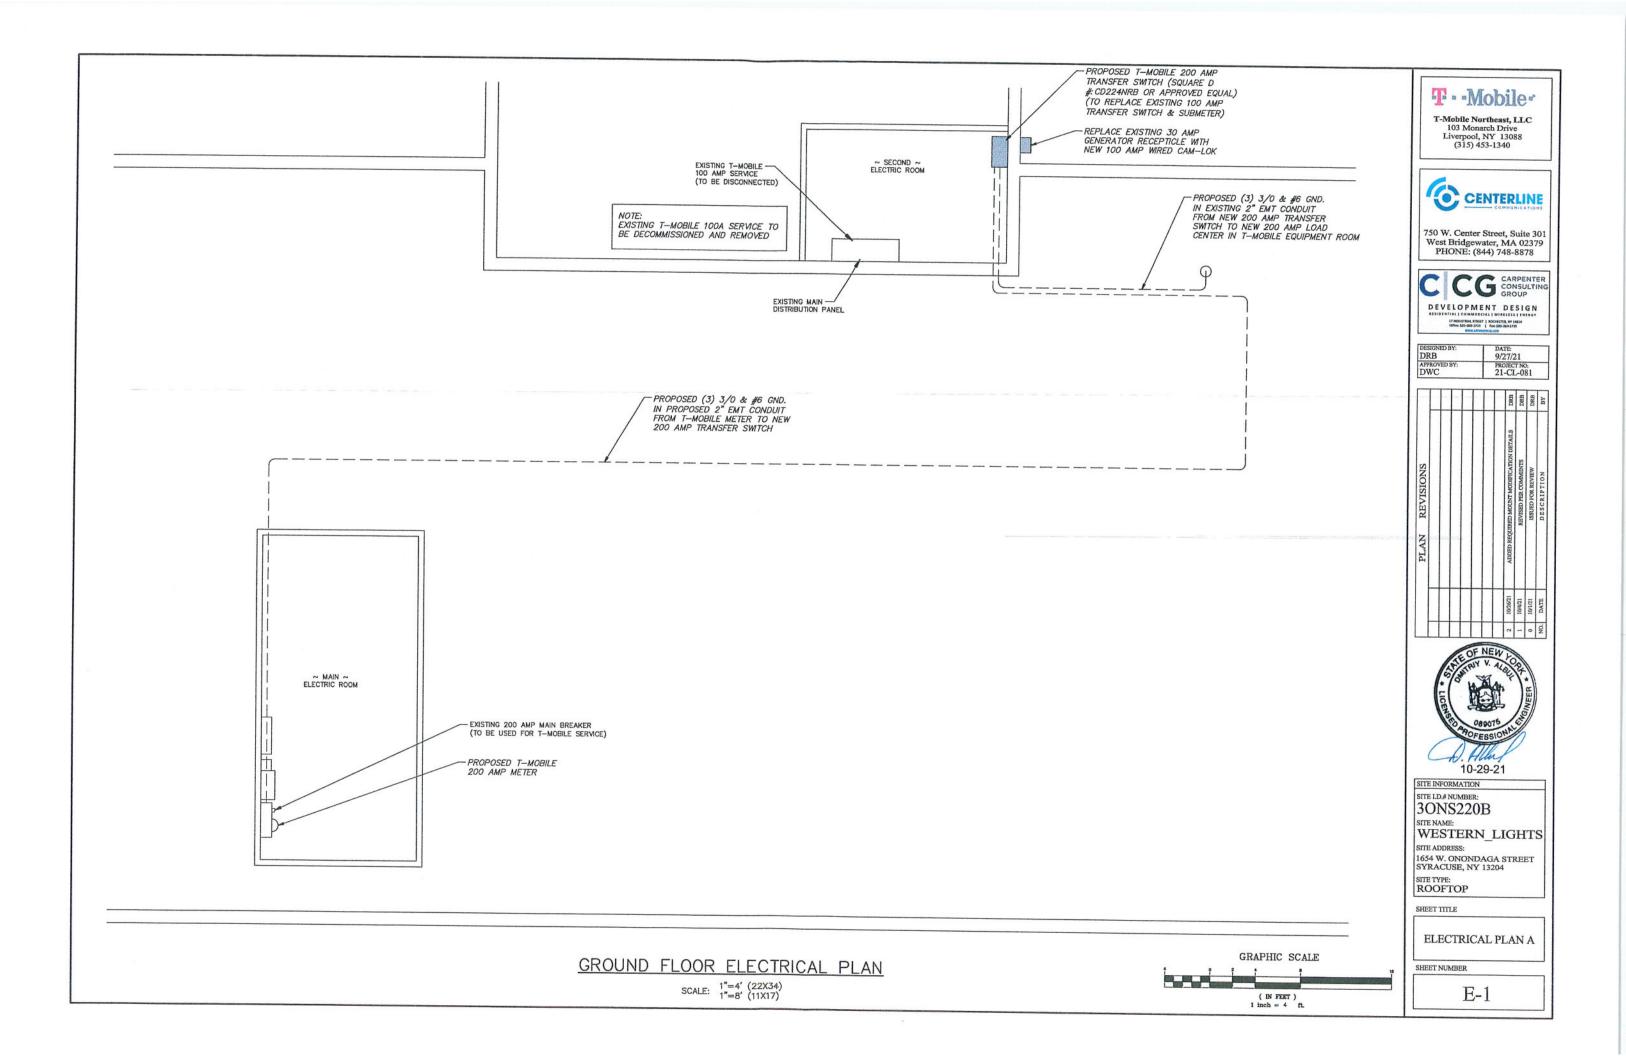
ANTENNA SPEC'S & DETAILS


SHEET NUMBER

C-4



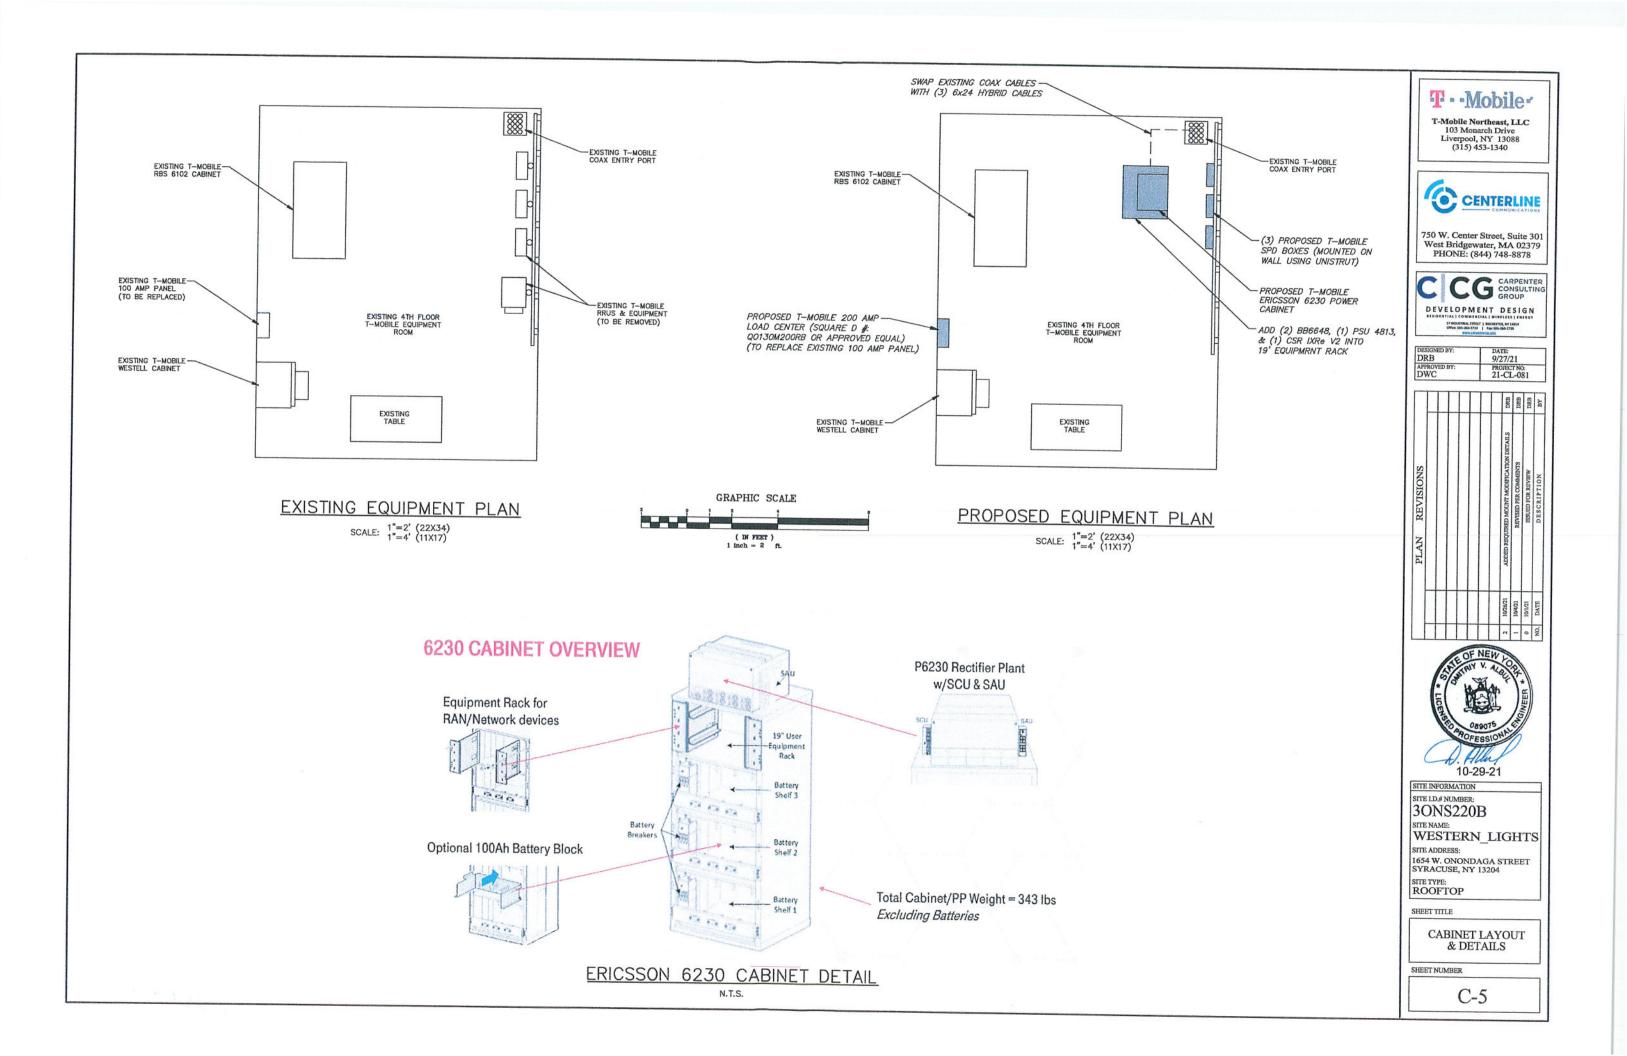

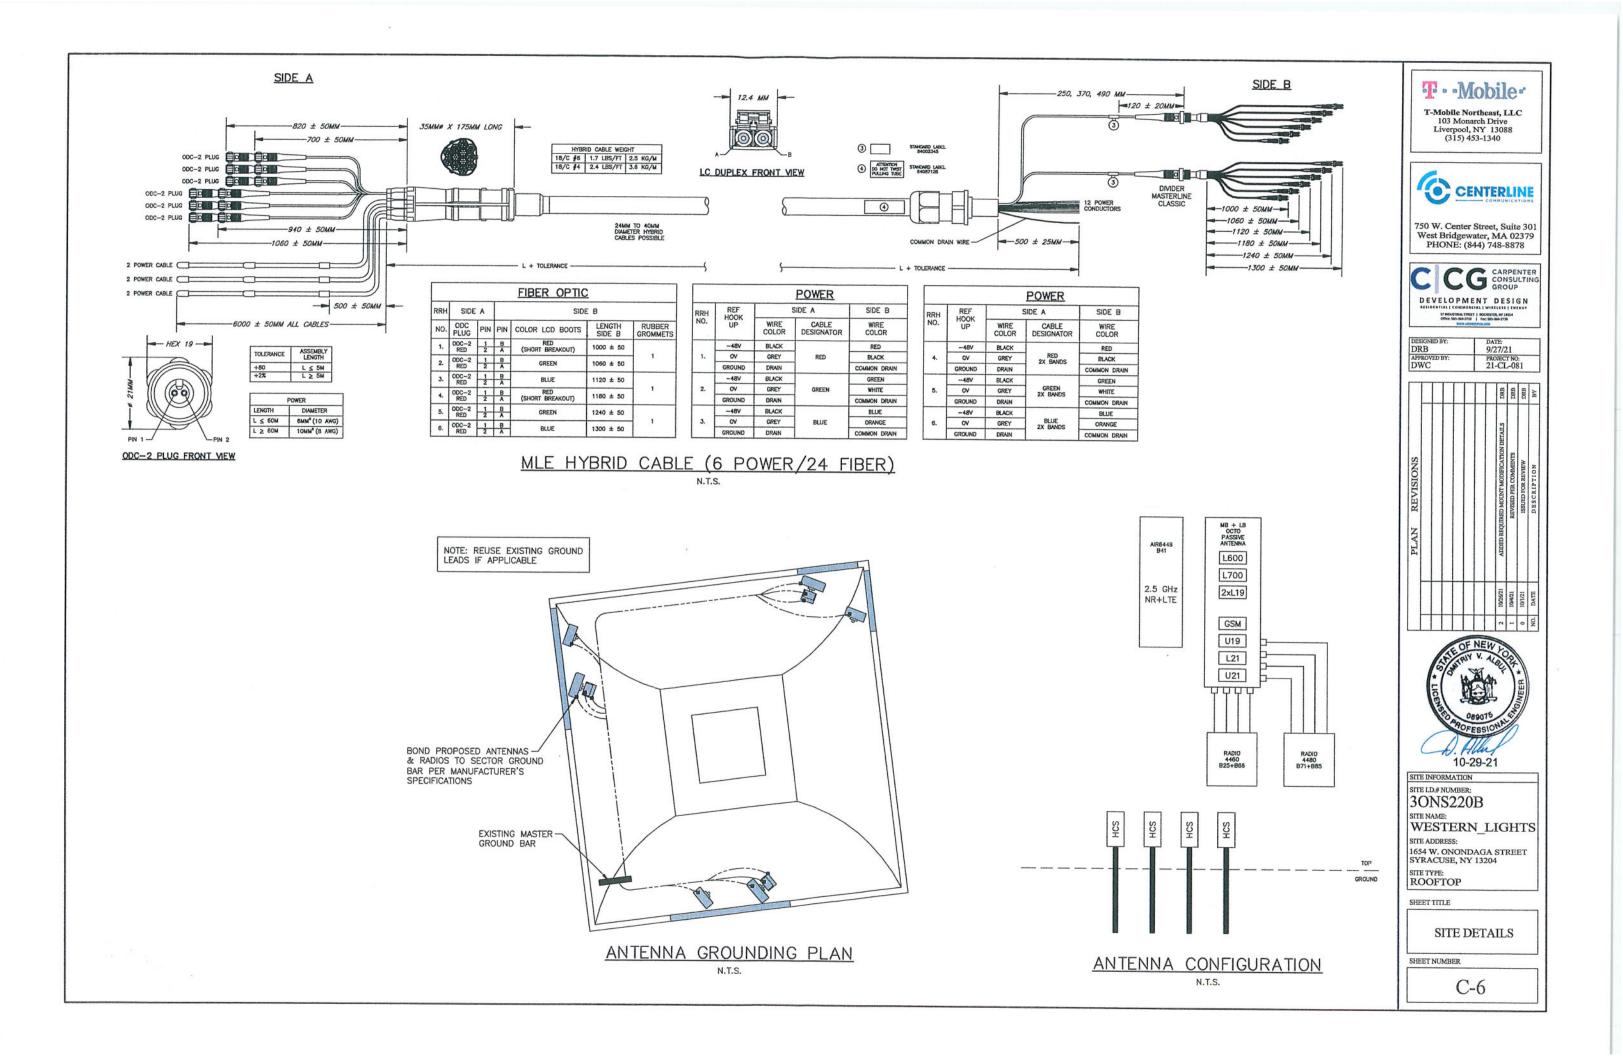

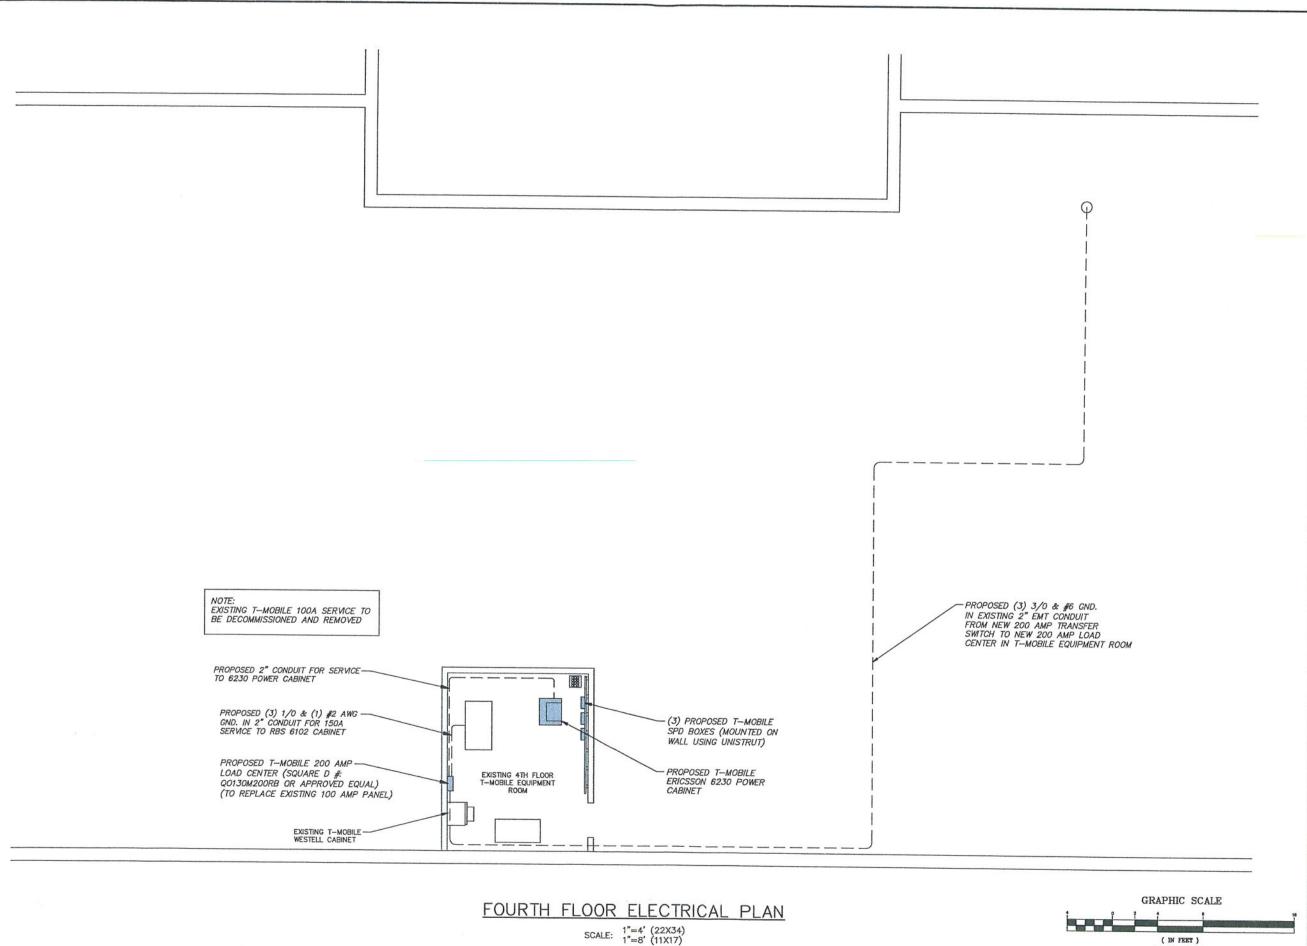



T-Mobile Northeast, LLC 103 Monarch Drive Liverpool, NY 13088 (315) 453-1340



750 W. Center Street, Suite 301 West Bridgewater, MA 02379 PHONE: (844) 748-8878



CCG CARPENTER CONSULTING GROUP

DEVELOPMENT DESIGN 17 WOLSTRIAL STREET | ROCHESTER, NY 14614 Office: 385-360-2733 | Fam: 585-360-2725

DESIGNED BY: DRB	DATE: 9/27/21
APPROVED BY:	PROJECT NO:
DWC	21-CL-081

PLAN REVISIONS ADDED REQUIRED MOUNT MODIFICATION DETAILS REVIEW RISHED PRE CAREATES RISHED FOR REVIEW D BS CR EPT 10 N		Н	+	-	L		DRB	DRB	DRB	BY
PLAN	REVISIONS						RED MOUNT MODIFICATION DETAILS	REVISED PER COMMENTS	ISSUED FOR REVIEW	DESCRIPTION
	PLAN						ADDED REQU			
		1	T			1	7	-	0	NO.



SITE INFORMATION

SITE I.D.# NUMBER: 30NS220B

SITE NAME: WESTERN_LIGHTS

SITE ADDRESS: 1654 W. ONONDAGA STREET SYRACUSE, NY 13204

SITE TYPE: ROOFTOP


SHEET TITLE

(IN FEET) 1 inch = 4 ft.

ELECTRICAL PLAN B

SHEET NUMBER

E-2

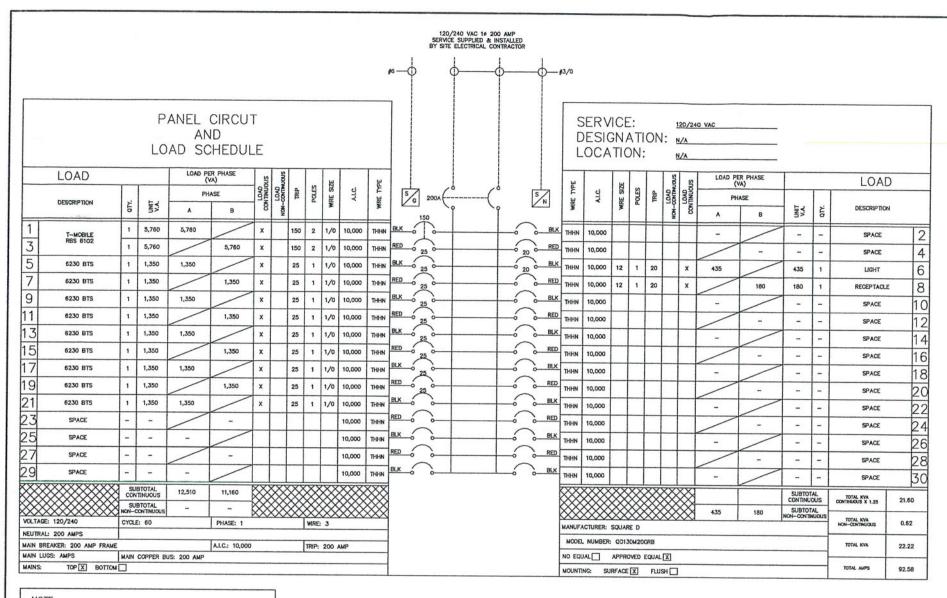

NOTE: CONTRACTOR TO SUPPLY & INSTALL THE FOLLOWING: SQUARE D MODEL Q0130M200RB 200 AMP 30 SPACE OUTDOOR MAIN BREAKER LOAD PANEL

ELECTRICAL PANEL
N.T.S.



SQUARE-D P	OWER PANEL DIMENSIONS
MODEL #	Q0130M200RB
MANUF.	SQUARE-D
MDTH	14.76"
HEIGHT	29.84"

ELECTRICAL PANEL DETAIL
N.T.S.



SQUARE-D DI	SCONNECT DIMENSIONS
MODEL #	CD224NR8
MANUF.	SQUARE-D
MDTH	19.0"
HEIGHT	29.25"

DISCONNECT SWITCH DETAIL
N.T.S.



T-Mobile Northeast, LLC 103 Monarch Drive Liverpool, NY 13088 (315) 453-1340



750 W. Center Street, Suite 301 West Bridgewater, MA 02379 PHONE: (844) 748-8878



DESIGNED BY:	DATE: 9/27/21
APPROVED BY:	PROJECT NO:
DWC	21-CL-081





SITE INFORMATION
SITE I.D.# NUMBER:
30NS220B
SITE NAME:

WESTERN_LIGHTS
SITE ADDRESS:
1654 W. ONONDAGA STREET
SYRACUSE, NY 13204
SITE TYPE:
ROOFTOP

SHEET TITLE

ELECTRICAL DETAILS


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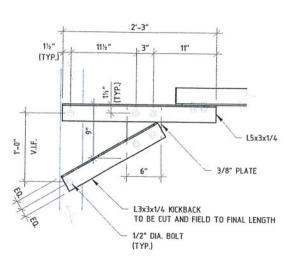
E-3




1. EQUIPMENT NOT SHOWN FOR CLARITY;

STEEPLE SHOWN PARTIALLY FOR CLARITY;
 VERIFY ALL DIMENSIONS PRIOR TO FABRICATION.



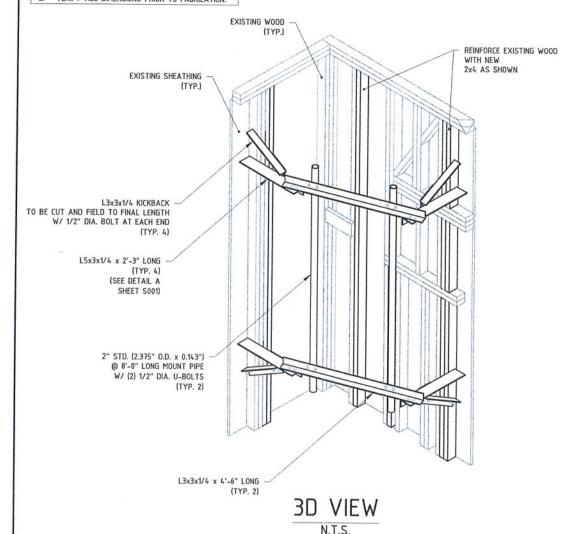




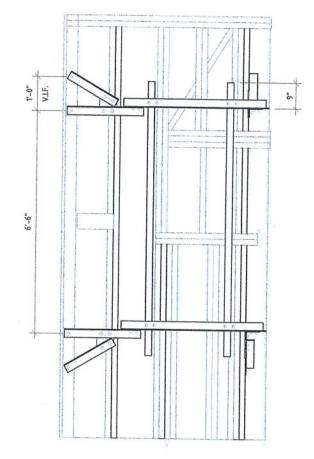

ELEVATION VIEW



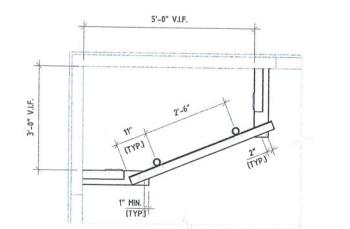

PLAN VIEW

STRUCTURAL STEEL MATERIAL PROPERTIES

1. Bolts:

ASTM A325

2. Pipes:

ASTM A53 Gr. B

3. Angles: 4. U-Bolts: ASTM A36 ASTM A307

ALL BOLTS ARE 1/2" DIA. MIN. UNLESS NOTED OTHERWISE.

NOTE: All structural steel should be Hot Dipped Galvanized per ASTM A123 / A123M. Provide shop drawings for structural steel for approval before fabrication.

INSTALLATION

- 1. All edge and gage distances should meet or exceed minimum values provided by AISC Manual of Steel Construction.
- 2. All structural steel fabrication, erection, and connections to conform with current edition of AISC handbook.

MISCELLANEOUS

- 1. It is solely the contractor's responsibility to determine erection procedure and sequence in order to insure the safety of the building, workmen, and occupants during construction (means & methods of construction). This includes, but is not limited to, the addition of shoring, under pinning, and temporary bracing, as necessary. USA Groups may bill contractor on a time and expense basis for additional work, for all new sketches, and for all additional review time related to means & methods.
- 2. Contractor shall survey the existing tower for all dimensions, elevations, and conditions needed to perform the work shown on these plans. This includes verifying dimensions, elevations, & conditions shown on the construction documents contractor shall report any non-conformance with design drawings to the USA Groups immediately.



T-MOBILE NORTHEAST, LLC 103 MONARCH DRIVE LIVERPOOL, NY 1308B (315) 453-1340



750 W. CENTER STREET, SUITE 301 WEST BRIDGEWATER, MA 02379 (844) 748-8878



DEVELOPMENT DESIGN 168 NORTH WATER STREET ROCHESTER, NY 14604 (585) 360-2733 WWW.CARPENTERCG.COM



3840 E. ROBINSON ROAD AMHERST, NY 14228 WWW.ALBULENG.COM

ISSUE STATUS



 DRAWN BY:
 AVM

 CHECKED BY:
 RSD

 DATE:
 10/22/2021

SITE INFORMATION

30NS220B WESTERN LIGHTS


1654 WEST ONONDAGA STREET SYRACUSE, NY 13204 ONONDAGA COUNTY


SOO

GENERAL NOTES &
ALPHA SECTOR MODIFICATION DESIGN




- EQUIPMENT NOT SHOWN FOR CLARITY; STEEPLE SHOWN PARTIALLY FOR CLARITY; VERIFY ALL DIMENSIONS PRIOR TO FABRICATION.

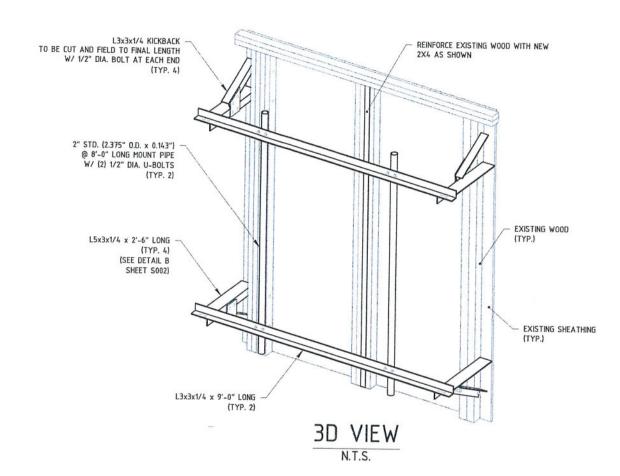


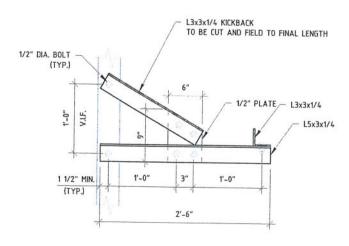

DETAIL B

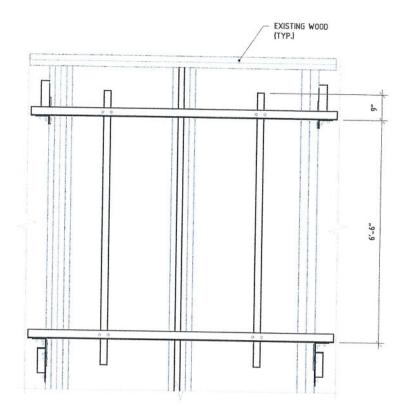

ELEVATION VIEW N.T.S.

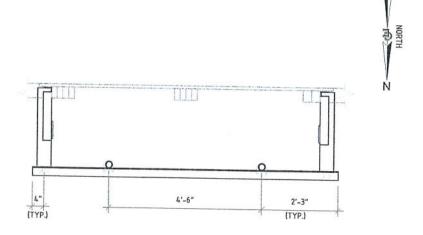

PLAN VIEW N.T.S.



T-MOBILE NORTHEAST, LLC 103 MONARCH DRIVE LIVERPOOL, NY 13088 (315) 453-1340



750 W. CENTER STREET, SUITE 301 WEST BRIDGEWATER, MA 02379





DEVELOPMENT DESIGN 168 NORTH WATER STREET ROCHESTER, NY 14604 (585) 360-2733 WWW.CARPENTERCG.COM



3840 E. ROBINSON ROAD AMHERST, NY 14228 WWW.ALBULENG.COM

ISSUE STATUS



DRAWN BY: AVM CHECKED BY: RSD DATE: 10/22/2021

SITE INFORMATION


30NS220B WESTERN LIGHTS


1654 WEST ONONDAGA STREET SYRACUSE, NY 13204 ONONDAGA COUNTY

SHEET:


BETA SECTOR MODIFICATION DESIGN

- 1. EQUIPMENT NOT SHOWN FOR CLARITY;
 2. STEEPLE SHOWN PARTIALLY FOR CLARITY;
 3. VERIFY ALL DIMENSIONS PRIOR TO FABRICATION.

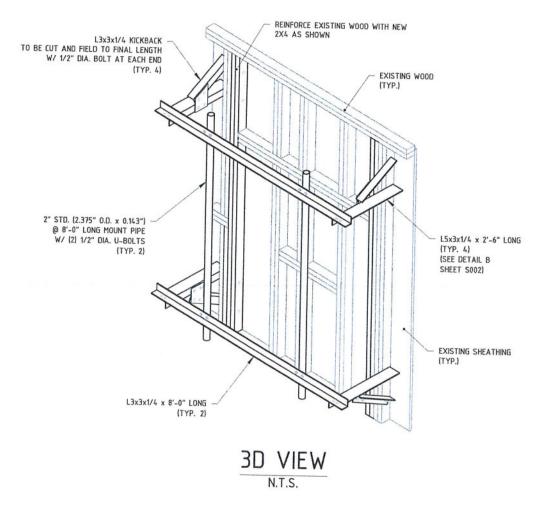

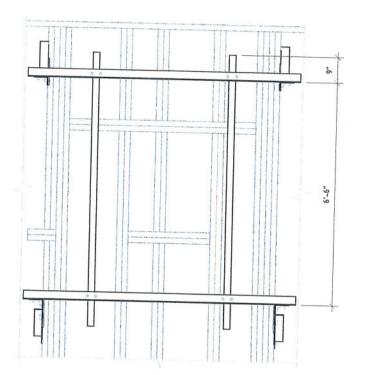

ELEVATION VIEW N.T.S.

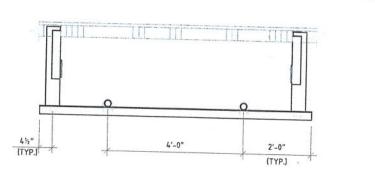

PLAN VIEW N.T.S.



T-MOBILE NORTHEAST, LLC 103 MONARCH DRIVE LIVERPOOL, NY 13088 (315) 453-1340



750 W. CENTER STREET, SUITE 301 WEST BRIDGEWATER, MA 02379 (844) 748-8878



DEVELOPMENT DESIGN 168 NORTH WATER STREET ROCHESTER, NY 14604 (585) 360-2733 WWW.CARPENTERCG.COM



3840 E. ROBINSON ROAD AMHERST, NY 14228 WWW.ALBULENG.COM

ISSUE STATUS



DRAWN BY: CHECKED BY: DATE:

NORTH 一印

> AVM RSD 10/22/2021

SITE INFORMATION 30NS220B

WESTERN LIGHTS

1654 WEST ONONDAGA STREET SYRACUSE, NY 13204 ONONDAGA COUNTY

S003 GAMMA SECTOR MODIFICATION DESIGN

RAN Template: 67E5A998E PBC6200+P6230 A&L Template: 67E5998E_1xAIR+1OP

3ONS220B_Anchor_9_draft

Print Name: Standard PORs: Anchor_Phase 3 L600_L600 Coverage

Section 1 - Site Information

Site ID: 3ONS220B Status: Draft Version: 9

Version: 9
Project Type: Anchor
Approved: Not Approved
Approved By: Not Approved
Last Modified: 7/27/2021 3:8:53 PM
Last Modified By: Gaurav.Patel1@T-Mobile.com

Site Name: western_lights Site Class: Rooftop Structure Site Type: Building Plan Year: 2022 Market: UPSTATE NY Vendor: Ericsson

Landlord: Catholic Charities

Latitude: 43.03406000 Longitude: -76.18174000 Address: 1654 West Onondaga Street

City, State: Syracuse, NY Region: NORTHEAST

RAN Template: 67E5A998E PBC6200+P6230

Sector Count: 3

Coax Line Count: 0


TMA Count: 0

AL Template: 67E5998E 1xAIR+10P

RRU Count: 6


Section 2 - Existing Template Images

4Sec-92DBA Hybrid.png

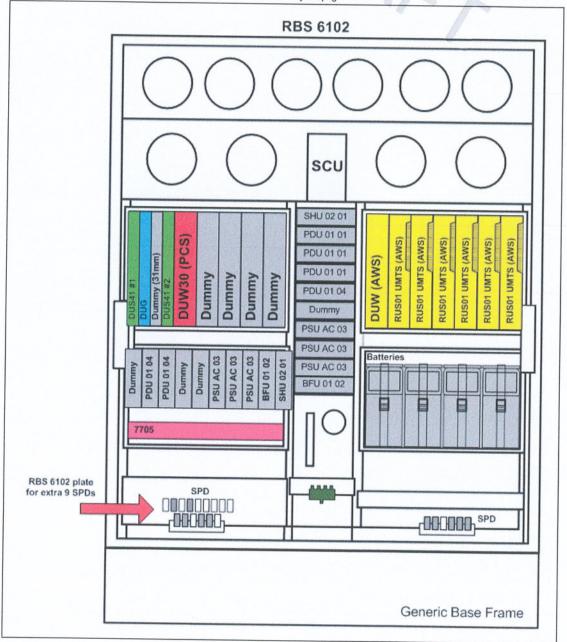


Notes:

4Sec-92DBA.png

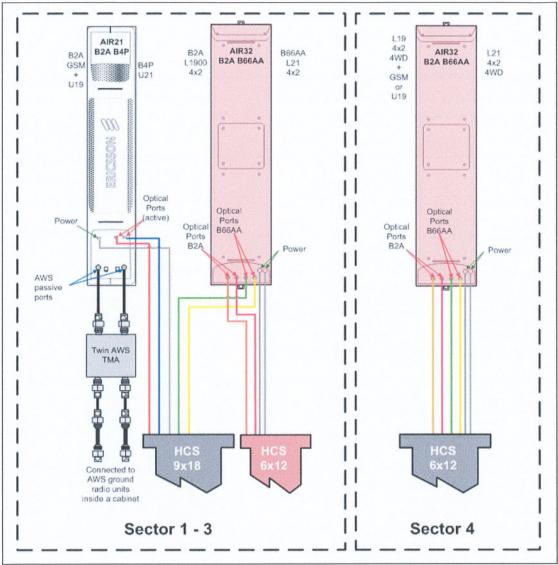

Section 3 - Proposed Template Images

67E5A998E.jpg

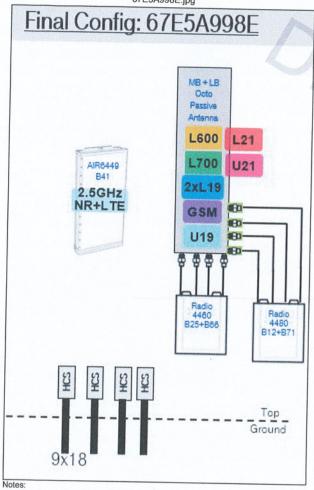

Section 4 - Siteplan Images

---- This section is intentionally blank. ----DRAFT RAN Template: 67E5A998E PBC6200+P6230

A&L Template: 67E5998E_1xAIR+1OP

3ONS220B_Anchor_9_draft

Print Name: Standard PORs: Anchor_Phase 3 L600_L600 Coverage

Section 5 - RAN Equipment

	Existing RAN Equipment
	Template: 4Sec-92DBA Hybrid
Enclosure	
Enclosure Type	(RBS 6102 MU AC)
Baseband	DUW30 (U1900) (U2100 (DECOMMISSIONED)) (G1900) (L2100 (L1900) (L1900)
Hybrid Cable System	(Ericsson 3x6 HCS *Select Length* (x 6)) (Ericsson 6x12 HCS *Select Length & AWG*)
Radio	RUS01 B4 (x 6) (U2100 (DECOMMISSIONED))

		Proposed RAN Equipment	
	т	emplate: 67E5A998E PBC6200+P6230	
Enclosure	1	2	3
Enclosure Type	RBS 6102 MU AC	(19 Inch Rack (Ericsson)	Power 6230
Baseband	DUG20 (G1900) (U1900)	BB 6648	
Hybrid Cable System	PSU 4813 Ericsson 3x6 HCS *Select Length* (x 6) Ericsson 6x12 HCS *Select Length & AWG*		PSU 4813 Ericsson Hybrid Trunk 6/24 4AWG 50m (x 3)
Transport System	(CSR 7210 SAS-Mxp) (CSR SAR-F)		CSR IXRe V2 (Gen2)

RAN Scope of Work:

RAN SOW;

NAME SOW;
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A&L SOW (total for site);
During Anchor upgrade we will remove Capacity additional sector.
Swap (3) Air32 antennas with (3) Air6449 antennas.
Swap (3) Air21 Antennas with 6' Octoport antennas, add (3) Radio 4480s for MM L7/L6/N6 to Low Band ports and add (3) Radio 4460 B25s for the 2xL19s/GSM to Mid Band ports.

A&L Template: 67E5998E_1xAIR+1OP RAN Template: 67E5A998E PBC6200+P6230

3ONS220B_Anchor_9_draft

Print Name: Standard PORs: Anchor_Phase 3 L600_L600 Coverage

Section 6 - A&L Equipment

Existing Template: 4Sec-92DBA_2xAIR
Proposed Template: 67E5998E_1xAIR+10P

		Sector 1 (Existing) v	riew from behind			
Coverage Type	A - Outdoor Macro		NA			
Antenna		4/%	7	2		
Antenna Model	Ericsson - AIR21 KRC118023	1_B2A_B4P (Quad)	Ericsson - AIR	32 KRD901146-1_B	66A_B2A (Octo)	
Azimuth	20		20			
M. Tilt	0		0			
Height	83		83)			
Ports	P1	P2	P3	P4	P5	P6
Active Tech.	U1900 G1900		L2100	L2100	L1900	L1900
Dark Tech.						
Restricted Tech.						
Decomm. Tech.		U2100				
E. Tilt	4	4	7	7	8	8
Cables						
TMAs						
Diplexers / Combiners						
Radio						
Sector Equipment						
Unconnected Equip	pment:					
Cable: 7/8" Coax -	65 ft. TMA: Ericsson Twin St	/le 1B - KRY 112 144/1				
Scope of Work:						
Cope of troit						

RAN Template: 67E5A998E PBC6200+P6230 A&L Template: 67E5998E_1xAIR+1OP

3ONS220B_Anchor_9_draft

Print Name: Standard PORs: Anchor_Phase 3 L600_L600 Coverage

			Sector 1 (Pre	oposed) view f	rom behind		
Coverage Type	A - Outdoor Macro	9					
Antenna						2	
Antenna Model	RFS - APXVAALL	18_43-U-NA20 (Octo	0)		Ericsson - AIR6449 B41 (Activ	ve Antenna - Massive MIMO)	
Azimuth	20				20		
M. Tilt	0				0		
Height	83				83		
Ports	P1	P2	P3	P4	P5	P6	
Active Tech.	L700 (L600) (N600)	L700 (L600) (N600)	G1900 U1900	G1900 U1900	L2500 N2500	(L2500) (N2500)	
Dark Tech.							
Restricted Tech.							
Decomm. Tech.							
E. Tilt	4	4	7	7	7	7	
Cables	Coax Jumper (x2)	Coax Jumper (x2)	Coax Jumper (x2)	Coax Jumper (x2)			
TMAs							
Diplexers / Combiners							
Radio	Radio 4480 B71+B85 (At Antenna)	SHARED Radio 4480 B71+B85 (At Antenna)	Radio 4460 B25+B66 (At Antenna)	SHARED Radio 4460 B25+B66 (At Antenna)			
Sector Equipment							
Unconnected Equip	oment:						
Scope of Work: During Anchor upgrade we will remove Capacity additional sector.							

*A dashed border indicates shared equipment. Any connected equipment is denoted with the SHARED keyword.

RAN Template: 67E5A998E PBC6200+P6230 A&L Template: 67E5998E_1xAIR+1OP 3ONS220B_Anchor_9_draft

		Sector 2 (Existing) v	iew from behind				
Coverage Type	A - Outdoor Macro						
Antenna				2			
Antenna Model	Ericsson - AIR21 KRC118023-	1_B2A_B4P (Quad)	Ericsson - AIR	32 KRD901146-1_B	66A_B2A (Octo)	***************************************	
Azimuth	230		230				
M. Tilt	0		0				
Height	83		(83)				
Ports	P1	P2	P3	P4	P5	P6	
Active Tech.	U1900 G1900		L2100	L2100	L1900	L1900	
Dark Tech.							
Restricted Tech.							
Decomm. Tech.		(U2100)					
E. Tilt	2	2	4	4	5	5	
Cables							
TMAs							
Diplexers / Combiners							
Radio							
Sector Equipment							
Unconnected Equip	oment:						
Cable: 7/8" Coax - 30 ft. TMA: Ericsson Twin Style 1B - KRY 112 144/1							
Scope of Work:							

RAN Template: 67E5A998E PBC6200+P6230

A&L Template: 67E5998E_1xAIR+1OP

3ONS220B_Anchor_9_draft

			Sector 2 (Pr	oposed) view f	rom behind	
Coverage Type	A - Outdoor Macro	9				
Antenna			1			2
Antenna Model	RFS - APXVAALL	(RFS - APXVAALL18_43-U-NA20 (Octo)				ve Antenna - Massive MIMO)
Azimuth	230				230	
M. Tilt	0				0	
Height	83				83)	
Ports	P1	P2	P3	P4	P5	P6
Active Tech.	L700 (L600) N600	(L700) (L600) (N600)	(L2100 (L1900) (G1900) (U1900)	(L2100 (L1900) (G1900) (U1900)	(L2500) (N2500)	(L2500) (N2500)
Dark Tech.						
Restricted Tech.						
Decomm. Tech.						
E. Tilt	4	4	4	4	4	4
Cables	Coax Jumper (x2)	Coax Jumper (x2)	Coax Jumper (x2)	Coax Jumper (x2)		
TMAs						
Diplexers / Combiners						
Radio	Radio 4480 B71+B85 (At Antenna)	SHARED Radio 4480 B71+B85 (At Antenna)	Radio 4460 B25+B66 (At Antenna)	SHARED Radio 4460 B25+B66 (At Antenna)		
Sector Equipment						
Swap (1) Air32 ant	rade we will remove (antennas.		L6/N6 to Low Band յ	oorts and add (1) Radio 4460 B2	5 for the 2xL19s/GSM/U19 to Mid Band ports.

RAN Template: A&L Template: 67E5A998E PBC6200+P6230 67E5998E_1xAIR+1OP

3ONS220B_Anchor_9_draft

		Sector 3 (Existing) v	iew from behind			
Coverage Type	A - Outdoor Macro					
Antenna			2			
Antenna Model	Ericsson - AIR21 KRC118023-	1_B2A_B4P (Quad)	Ericsson - AIR	32 KRD901146-1_B	66A_B2A (Octo)	
Azimuth	290		290			
M. Tilt	0		0			
Height	83		83			
Ports	P1	P2	P3	P4	P5	P6
Active Tech.	U1900 G1900		L2100	L2100	L1900	L1900
Dark Tech.						
Restricted Tech.						
Decomm. Tech.		U2100				
E. Tilt	3	3	4	4	5	5
Cables						
TMAs						
Diplexers / Combiners						
Radio						
Sector Equipment						
Unconnected Equip	pment:					
Cable: 7/8" Coax -	- 45 ft. TMA: Ericsson Twin Sty	yle 1B - KRY 112 144/1				
Scope of Work:						

RAN Template: A&L Template: 67E5A998E PBC6200+P6230 67E5998E_1xAIR+1OP

3ONS220B_Anchor_9_draft

Print Name: Standard PORs: Anchor_Phase 3 L600_L600 Coverage

			Sector 3 (Pro	posed) view fi	on beinia	
Coverage Type	A - Outdoor Macro)				
Antenna		1				2
Antenna Model	RFS - APXVAALL	18_43-U-NA20 (Octo			Ericsson - AIR6449 B41 (Active	e Antenna - Massive MIMO)
Azimuth	290				290	
M. Tilt	0				0	
Height	83				83	
Ports	P1	P2	P3	P4	P5	P6
Active Tech.	L700 (L600) (N600)	L700 (L600) (N600)	G1900 U1900	G1900 U1900	L2500 N2500	L2500 N2500
Dark Tech.						
Restricted Tech.						
Decomm. Tech.						
E. Tilt	4	4	4	4	4	4
Cables	Coax Jumper (x2)	Coax Jumper (x2)	Coax Jumper (x2)	Coax Jumper (x2)		
TMAs						
Diplexers / Combiners						
Radio	Radio 4480 B71+B85 (At Antenna)	SHARED Radio 4480 B71+B85 (At Antenna)	Radio 4460 B25+B66 (At Antenna)	SHARED Radio 4460 B25+B66 (At Antenna)		
Sector Equipment						
Unconnected Equip	oment:					

*A dashed border indicates shared equipment. Any connected equipment is denoted with the SHARED keyword.

401 A 0 1/04

RAN Template: 67E5A998E PBC6200+P6230 A&L Template: 67E5998E_1xAIR+1OP 3ONS220B_Anchor_9_draft

		Sector 4 (Existing) v	iew from behind				
Coverage Type	A - Outdoor Macro						
Antenna			1				
Antenna Model	Ericsson - AIR32 KRD901146-	1_B66A_B2A (Octo)					
Azimuth	100						
M. Tilt	0						
Height	83						
Ports	P1	P2	P3	P4			
Active Tech.	L2100	L2100	U1900 L1900	U1900 (L1900)			
Dark Tech.							
Restricted Tech.							
Decomm. Tech.							
E. Tilt	2	2	2	2			
Cables							
TMAs							
Diplexers / Combiners							
Radio							
Sector Equipment							
Unconnected Equipment: Scope of Work:							
This AIR32 B66Aa/	This AIR32 B66Aa/B2a DB antenna is on the RIGHT side of the First (Alpha) Sector outside of structure.						

RAN Template: 67E5A998E PBC6200+P6230 **A&L Template:** 67E5998E_1xAIR+1OP

3ONS220B_Anchor_9_draft

Print Name: Standard PORs: Anchor_Phase 3

		L600_L600 Cov
	Sec	on 7 - Power Systems Equipment
		xisting Power Systems Equipment
		This section is intentionally blank
	Section Assessment Committee of the Comm	
	Р	oposed Power Systems Equipment
Enclosure		1
Enclosure Type	Power 6230)	

Full Environmental Assessment Form Part 1 - Project and Setting

Instructions for Completing Part 1

Part 1 is to be completed by the applicant or project sponsor. Responses become part of the application for approval or funding, are subject to public review, and may be subject to further verification.

Complete Part 1 based on information currently available. If additional research or investigation would be needed to fully respond to any item, please answer as thoroughly as possible based on current information; indicate whether missing information does not exist, or is not reasonably available to the sponsor; and, when possible, generally describe work or studies which would be necessary to update or fully develop that information.

Applicants/sponsors must complete all items in Sections A & B. In Sections C, D & E, most items contain an initial question that must be answered either "Yes" or "No". If the answer to the initial question is "Yes", complete the sub-questions that follow. If the answer to the initial question is "No", proceed to the next question. Section F allows the project sponsor to identify and attach any additional information. Section G requires the name and signature of the applicant or project sponsor to verify that the information contained in Part 1 is accurate and complete.

A. Project and Applicant/Sponsor Information.

Project Location (describe, and attach a general location map): 1654 W. Onondaga Street, Syracuse, Onondaga County, NY 13204 (43.0340638° N / -76.1818607° W) Brief Description of Proposed Action (include purpose or need): T-Mobile proposes the modification of an existing unmanned wireless telecommunications facility. Specifically, the following will be completed: Upgrade 100A electric service to 200A, add power 6230 cabinett, add 19° Ericsson rack, add (2) BB 6648, (1) FSU 4813 & (1) IXRe router to 19° rack, add (3) indoor SPD boxes, swap existing coax cables with (3) 6x24 hybrid cables, swap (3) AIR32 antennas with (3) AIR6449 antennas, swap (3) AIR21 antennas with 6° octoport antennas, add (3) radio 4480S and add (3) radio 4460 B25S. Remove existing TMA's. Name of Applicant/Sponsor: T-Mobile Northeast, LLC Address: 103 Monarch Drive City/PO: Liverpool Project Contact (if not same as sponsor; give name and title/role): Kelley Cross Address: 750 West Center Street, Suite 301 City/PO: West Bridgewater Property Owner (if not same as sponsor): Telephone: State: Zip Code: MA 02379 Property Owner (if not same as sponsor): Telephone:	Name of Action or Project:			
Brief Description of Proposed Action (include purpose or need): T-Mobile proposes the modification of an existing unmanned wireless telecommunications facility. Specifically, the following will be completed: Upgrade 100A electric service to 200A, add power 6230 cabinet, add 19° Eriosson rack, add (2) BB 6648, (1) PSU 4813 & (1) IXFe router to 19° rack, add (3) indoor SPD boxes, swap existing coax cables with (3) 6x24 hybrid cables, swap (3) AIR32 antennas with (3) AIR6449 antennas, swap (3) AIR21 antennas with 6' octoport antennas, add (3) radio 4480S and add (3) radio 4460 B25S. Remove existing TMA's. Name of Applicant/Sponsor:	3ONS220B (CK21-9976)			
Brief Description of Proposed Action (include purpose or need): T-Mobile proposes the modification of an existing unmanned wireless telecommunications facility. Specifically, the following will be completed: Upgrade 100A electric service to 200A, add power 6230 cabinet, add 19° Ericsson rack, add (2) BB 6648, (1) PSU 4813 & (1) IXFe router to 19" rack, add (3) indoor SPD boxes, swap existing coax cables with (3) 6x24 hybrid cables, swap (3) AIR22 antennas with (3) AIR6449 antennas, swap (3) AIR21 antennas with 6' octoport antennas, add (3) radio 4480S and add (3) radio 4460 B25S. Remove existing TMA's. Telephone: (315) 461-0345 E-Mail: N/A Address: 103 Monarch Drive City/PO: Liverpool Project Contact (if not same as sponsor; give name and title/role): Kelley Cross Address: Telephone: (657) 237-9590 E-Mail: kcross@clinellc.com Address: Totophone: Titlephone: Titlephone: Titlephone: Titlephone: Titlephone: Titlephone: Titlephone: Titlephone: Titlephone: Titlephone: Titlephone: Titlephone: Titlephone: Thobbile Northeast, LLC (same as Applicant/Sponsor): Thobbile Northeast, LLC (same as Applicant/Sponsor)	Project Location (describe, and attach a general location map):			
T-Mobile proposes the modification of an existing unmanned wireless telecommunications facility. Specifically, the following will be completed: Upgrade 100A electric service to 200A, add power 6230 cabinett, add 19° Ericsson rack, add (2) BB 6648, (1) PSU 4813 & (1) IXRe router to 19° rack, add (3) indoor SPD boxes, swap existing coax cables with (3) AlPS2 antennas with (3) AIR6449 antennas, swap (3) AIR21 antennas with 6° octoport antennas, add (3) radio 4480S and add (3) radio 4460 B25S. Remove existing TMA's. Name of Applicant/Sponsor: T-Mobile Northeast, LLC Address: 103 Monarch Drive City/PO: Liverpool City/PO: Liverpool Project Contact (if not same as sponsor; give name and title/role): Kelley Cross Address: Telephone: (657) 237-9590 E-Mail: kcross@clinellc.com Address: 750 West Center Street, Suite 301 City/PO: West Bridgewater MA Property Owner (if not same as sponsor): Telephone: Telephone:	1654 W. Onondaga Street, Syracuse, Onondaga County, NY 13204 (43.0340638° N /	-76.1818607° W)		
Upgrade 100A electric service to 200A, add power 6230 cabinet, add 19" Ericsson rack, add (2) BB 6848, (1) PSU 4813 & (1) IXRe router to 19" rack, add (3) indoor SPD boxes, swap existing coax cables with (3) 6x24 hybrid cables, swap (3) AIR32 antennas with (3) AIR6449 antennas, swap (3) AIR21 antennas with 6" octoport antennas, add (3) radio 4480S and add (3) radio 4460 B25S. Remove existing TMA's. Name of Applicant/Sponsor:	Brief Description of Proposed Action (include purpose or need):			
T-Mobile Northeast, LLC Address: 103 Monarch Drive City/PO: Liverpool Project Contact (if not same as sponsor; give name and title/role): Kelley Cross Address: 750 West Center Street, Suite 301 City/PO: West Bridgewater Property Owner (if not same as sponsor): T-Mobile Northeast, LLC (same as Applicant/Sponsor) Address: Telephone: (657) 237-9590 E-Mail: kcross@clinellc.com State: Zip Code: O2379 Telephone: T-Mobile Northeast, LLC (same as Applicant/Sponsor) E-Mail: MA Description: E-Mail: MA Description: Telephone: E-Mail: MA Description: Telephone: Telephone: Telephone: Telephone: Telephone:	Upgrade 100A electric service to 200A, add power 6230 cabinet, add 19" Ericsson rac (3) indoor SPD boxes, swap existing coax cables with (3) 6x24 hybrid cables, swap (3)	k, add (2) BB 6648, (1) PSU 48) AIR32 antennas with (3) AIR64	13 & (1) IXRe router to 19" rack, add	
T-Mobile Northeast, LLC Address: 103 Monarch Drive City/PO: Liverpool Project Contact (if not same as sponsor; give name and title/role): Kelley Cross Address: 750 West Center Street, Suite 301 City/PO: West Bridgewater Property Owner (if not same as sponsor): T-Mobile Northeast, LLC (same as Applicant/Sponsor) Address: T-Mail: N/A State: NY Telephone: (657) 237-9590 E-Mail: kcross@clinellc.com State: Zip Code: 02379 Telephone: T-Mobile Northeast, LLC (same as Applicant/Sponsor) E-Mail: Address:	Name of Applicant/Sponsor:	Telephone: (315) 461	-0345	
City/PO: Liverpool Project Contact (if not same as sponsor; give name and title/role): Kelley Cross Address: 750 West Center Street, Suite 301 City/PO: West Bridgewater Property Owner (if not same as sponsor): T-Mobile Northeast, LLC (same as Applicant/Sponsor) State: NY Telephone: (657) 237-9590 E-Mail: kcross@clinellc.com State: Zip Code: MA 02379 Telephone: T-Mail: E-Mail: E-Mail:	T-Mobile Northeast, LLC			
Project Contact (if not same as sponsor; give name and title/role): Kelley Cross E-Mail: kcross@clinellc.com Address: 750 West Center Street, Suite 301 City/PO: West Bridgewater Property Owner (if not same as sponsor): T-Mobile Northeast, LLC (same as Applicant/Sponsor) Address: Telephone: (657) 237-9590 E-Mail: kcross@clinellc.com State: MA 02379 Telephone: E-Mail: Address:	Address: 103 Monarch Drive			
Kelley Cross E-Mail: kcross@clinellc.com Address: 750 West Center Street, Suite 301 City/PO: West Bridgewater Property Owner (if not same as sponsor): T-Mobile Northeast, LLC (same as Applicant/Sponsor) Address:	City/PO: Liverpool	State: NY	Zip Code: 13088	
Address: 750 West Center Street, Suite 301 City/PO: West Bridgewater MA Property Owner (if not same as sponsor): T-Mobile Northeast, LLC (same as Applicant/Sponsor) Address: E-Mail: E-Mail:	Project Contact (if not same as sponsor; give name and title/role):	Telephone: (657) 237	7-9590	
Address: 750 West Center Street, Suite 301 City/PO: West Bridgewater MA Property Owner (if not same as sponsor): T-Mobile Northeast, LLC (same as Applicant/Sponsor) Address: T-Motile Northeast, LLC (same as Applicant/Sponsor) Address:	Kelley Cross	E-Mail: kcross@cline	E-Mail: kcross@clinellc.com	
West Bridgewater Property Owner (if not same as sponsor): T-Mobile Northeast, LLC (same as Applicant/Sponsor) E-Mail:	Address: 750 West Center Street, Suite 301			
Property Owner (if not same as sponsor): T-Mobile Northeast, LLC (same as Applicant/Sponsor) E-Mail: Address:	City/PO:	State:	Zip Code:	
T-Mobile Northeast, LLC (same as Applicant/Sponsor) E-Mail: Address:	West Bridgewater	MA	02379	
Address:	Property Owner (if not same as sponsor):	Telephone:	Telephone:	
	T-Mobile Northeast, LLC (same as Applicant/Sponsor)	E-Mail:	E-Mail:	
City/PO: State: Zip Code:	Address:			
	City/PO:	State:	Zip Code:	

B. Government Approvals

B. Government Approvals assistance.)	s, Funding, or Spor	nsorship. ("Funding" includes grants, loans, ta	ax relief, and any other	forms of financial
Government	Entity	If Yes: Identify Agency and Approval(s) Required	Applicati (Actual or p	
a. City Counsel, Town Boar or Village Board of Trus				
b. City, Town or Village Planning Board or Comn	✓Yes □No nission	Planning Board - Special Use Permit, Site Plan Review and Building Permit	TBD	
c. City, Town or Village Zoning Board of	☑Yes □No Appeals	Zoning Board - Special Use Permit, Site Plan Review and Building Permit	TBD	
d. Other local agencies	□Yes ∠ No			
e. County agencies	□Yes ✓No			
f. Regional agencies	□Yes☑No			
g. State agencies	∠ Yes□No	NYSHPO	TBD	
h. Federal agencies	Z Yes□No	FCC License	TBD	
 ii. Is the project site loca iii. Is the project site with C. Planning and Zoning C.1. Planning and zoning Will administrative or legist only approval(s) which mu If Yes, complete see 	actions. lative adoption, or a st be granted to enal ections C, F and G.	with an approved Local Waterfront Revitalizate Hazard Area? mendment of a plan, local law, ordinance, rule ple the proposed action to proceed? mplete all remaining sections and questions in I	or regulation be the	☐ Yes ZNo ☐ Yes ZNo ☐ Yes ZNo ☐ Yes ZNo
C.2. Adopted land use pla	ns.			
where the proposed actio	n would be located?	lage or county) comprehensive land use plan(s		□Yes ☑ No
b. Is the site of the proposed	d action within any l Area (BOA); design	ocal or regional special planning district (for e lated State or Federal heritage area; watershed	xample: Greenway; management plan;	□Yes ☑ No
c. Is the proposed action lo or an adopted municipal If Yes, identify the plan(s):		ially within an area listed in an adopted munic n plan?	ipal open space plan,	□Yes ZNo

C.3. Zoning	
a. Is the site of the proposed action located in a municipality with an adopted zoning law or ordinance. If Yes, what is the zoning classification(s) including any applicable overlay district? Residential District RB	☑Yes□No
1. If the constituted an allowed by a propied on conditional two magnity	∠ Yes No
b. Is the use permitted or allowed by a special or conditional use permit?	
c. Is a zoning change requested as part of the proposed action? If Yes, i. What is the proposed new zoning for the site?	□Yes Z No
C.4. Existing community services.	
a. In what school district is the project site located? Syracuse School District	
b. What police or other public protection forces serve the project site? Syracuse Police Department	
c. Which fire protection and emergency medical services serve the project site? Syracuse Fire Department	
d. What parks serve the project site? James J. O'Connor Park	
D. Project Details	
D.1. Proposed and Potential Development	
a. What is the general nature of the proposed action (e.g., residential, industrial, commercial, recreational; if mixe components)? Modification of an existing unmanned wireless telecommunications facility.	d, include all
b. a. Total acreage of the site of the proposed action? 0.001 acres	
b. Total acreage to be physically disturbed? acres	
c. Total acreage (project site and any contiguous properties) owned or controlled by the applicant or project sponsor? 0.001 acres	
c. Is the proposed action an expansion of an existing project or use? i. If Yes, what is the approximate percentage of the proposed expansion and identify the units (e.g., acres, miles square feet)? % Units:	☐ Yes☑ No s, housing units,
d. Is the proposed action a subdivision, or does it include a subdivision?	□Yes Z No
If Yes, i. Purpose or type of subdivision? (e.g., residential, industrial, commercial; if mixed, specify types)	
ii. Is a cluster/conservation layout proposed?iii. Number of lots proposed?	□Yes ☑No
e. Will the proposed action be constructed in multiple phases?	☐ Yes Z No
i. If No, anticipated period of construction: ii. If Yes:	1032110
Total number of phases anticipated	
 Anticipated commencement date of phase 1 (including demolition) month year Anticipated completion date of final phase month year 	ess of one phase may
Generally describe connections or relationships among phases, including any contingencies where prograde determine timing or duration of future phases:	ess of one phase may

f. Does the project include new residential uses? If Yes, show numbers of units proposed.	□Yes ☑ No
One Family Two Family Three Family Multiple Family (four or more)	
Initial Phase	
At completion	
of all phases	
g. Does the proposed action include new non-residential construction (including expansions)? If Yes, i. Total number of structures	Z Yes□No
ii. Dimensions (in feet) of largest proposed structure: 6' height; 8.5" width; and 24" length iii. Approximate extent of building space to be heated or cooled: 0 square feet	
h. Does the proposed action include construction or other activities that will result in the impoundment of any liquids, such as creation of a water supply, reservoir, pond, lake, waste lagoon or other storage? If Yes, i. Purpose of the impoundment:	□Yes ☑No
i. Purpose of the impoundment: ii. If a water impoundment, the principal source of the water: ☐ Ground water ☐ Surface water stre	ams Other specify:
iii. If other than water, identify the type of impounded/contained liquids and their source.	
 iv. Approximate size of the proposed impoundment. Volume: million gallons; surface area: v. Dimensions of the proposed dam or impounding structure: height; length 	acres
vi. Construction method/materials for the proposed dam or impounding structure (e.g., earth fill, rock, wood, construction method/materials for the proposed dam or impounding structure (e.g., earth fill, rock, wood, construction method/materials for the proposed dam or impounding structure (e.g., earth fill, rock, wood, construction method/materials for the proposed dam or impounding structure).	ncrete):
D.2. Project Operations	
a. Does the proposed action include any excavation, mining, or dredging, during construction, operations, or both (Not including general site preparation, grading or installation of utilities or foundations where all excavated materials will remain onsite) If Yes:	? ☐Yes ∏ No
i. What is the purpose of the excavation or dredging?ii. How much material (including rock, earth, sediments, etc.) is proposed to be removed from the site?	
 Now much material (including rock, earth, sediments, etc.) is proposed to be removed from the site? Volume (specify tons or cubic yards): 	
Over what duration of time?	
iii. Describe nature and characteristics of materials to be excavated or dredged, and plans to use, manage or dispo	se of them.
iv. Will there be onsite dewatering or processing of excavated materials?	☐Yes ✓ No
If yes, describe.	
v. What is the total area to be dredged or excavated?	
vi. What is the maximum area to be worked at any one time? acres	
vii. What would be the maximum depth of excavation or dredging?	D. D.
viii. Will the excavation require blasting?	☐Yes Z No
ix. Summarize site reclamation goals and plan:	
b. Would the proposed action cause or result in alteration of, increase or decrease in size of, or encroachment into any existing wetland, waterbody, shoreline, beach or adjacent area?	☐Yes Z No
If Yes:i. Identify the wetland or waterbody which would be affected (by name, water index number, wetland map num description):	ber or geographic

alteration of channels, banks and shorelines. Indicate extent of activities, alterations and additions in squa	re feet or acres:
i. Will the proposed action cause or result in disturbance to bottom sediments?	
If Yes, describe:	□Yes□No
v. Will the proposed action cause or result in the destruction or removal of aquatic vegetation?	□Yes□No
If Yes:	
acres of aquatic vegetation proposed to be removed:	
expected acreage of aquatic vegetation remaining after project completion:	
purpose of proposed removal (e.g. beach clearing, invasive species control, boat access):	
proposed method of plant removal:	
 if chemical/herbicide treatment will be used, specify product(s): 	
Describe any proposed reclamation/mitigation following disturbance:	
Will the proposed action use, or create a new demand for water?	□Yes Z No
Yes:	
Total anticipated water usage/demand per day: gallons/day Will the proposed action obtain water from an existing public water supply?	
es:	□Yes □No
Name of district or service area:	
Does the existing public water supply have capacity to serve the proposal?	□Yes□No
• Is the project site in the existing district?	☐ Yes ☐ No
Is expansion of the district needed?	☐Yes☐No
• Do existing lines serve the project site?	☐ Yes ☐ No
Will line extension within an existing district be necessary to supply the project?	□Yes □No
es:	
Describe extensions or capacity expansions proposed to serve this project:	
Source(s) of an all the training	
Source(s) of supply for the district: Is a new water supply district or service area proposed to be formed to a service.	
Is a new water supply district or service area proposed to be formed to serve the project site? Yes:	☐ Yes☐No
 Applicant/sponsor for new district: Date application submitted or anticipated: 	
Proposed source(s) of supply for new district:	
If a public water supply will not be used, describe plans to provide water supply for the project:	
If water supply will be from wells (public or private), what is the maximum pumping capacity: ga	allons/minute.
Will the proposed action generate liquid wastes?	☐ Yes Z No
/es:	
Total anticipated liquid waste generation per day: gallons/day	
Nature of liquid wastes to be generated (e.g., sanitary wastewater, industrial; if combination, describe all c	
approximate volumes or proportions of each):	
Will the proposed action we are existing while which the day of C. The D	
Will the proposed action use any existing public wastewater treatment facilities? If Yes:	☐ Yes ☐ No
Name of wastewater treatment plant to be used:	
Name of district:	
Does the existing wastewater treatment plant have capacity to serve the project?	□Yes□No
Is the project site in the existing district?	□Yes □No
Is expansion of the district needed?	☐Yes ☐No

Do existing sewer lines serve the project site?	□Yes□No
 Will a line extension within an existing district be necessary to serve the project? If Yes: 	□Yes□No
Describe extensions or capacity expansions proposed to serve this project:	
Section of expansions proposed to solve this project.	
iv. Will a new wastewater (sewage) treatment district be formed to serve the project site?	□Yes□No
If Yes: • Applicant/sponsor for new district:	
 Applicant/sponsor for new district: Date application submitted or anticipated: 	
What is the receiving water for the wastewater discharge?	
v. If public facilities will not be used, describe plans to provide wastewater treatment for the project, including specire receiving water (name and classification if surface discharge or describe subsurface disposal plans):	ifying proposed
vi. Describe any plans or designs to capture, recycle or reuse liquid waste:	
e. Will the proposed action disturb more than one acre and create stormwater runoff, either from new point	□Yes ZNo
sources (i.e. ditches, pipes, swales, curbs, gutters or other concentrated flows of stormwater) or non-point source (i.e. sheet flow) during construction or post construction? If Yes:	
i. How much impervious surface will the project create in relation to total size of project parcel?	
Square feet or acres (impervious surface) Square feet or acres (parcel size)	
Square feet or acres (parcel size)	
ii. Describe types of new point sources.	
iii. Where will the stormwater runoff be directed (i.e. on-site stormwater management facility/structures, adjacent progroundwater, on-site surface water or off-site surface waters)?	roperties,
If to surface waters, identify receiving water bodies or wetlands:	
Will stormwater runoff flow to adjacent properties?	□Yes□No
<i>iv.</i> Does the proposed plan minimize impervious surfaces, use pervious materials or collect and re-use stormwater?	□Yes□No
f. Does the proposed action include, or will it use on-site, one or more sources of air emissions, including fuel combustion, waste incineration, or other processes or operations? If Yes, identify:	∠ Yes □ No
i. Mobile sources during project operations (e.g., heavy equipment, fleet or delivery vehicles)	
Only during construction phase - cranes, etc. ii. Stationary sources during construction (e.g., power generation, structural heating, batch plant, crushers)	
Only during construction phase - cranes, etc. iii. Stationary sources during operations (e.g., process emissions, large boilers, electric generation) Only during construction phase - cranes, etc.	
g. Will any air emission sources named in D.2.f (above), require a NY State Air Registration, Air Facility Permit, or Federal Clean Air Act Title IV or Title V Permit? If Yes:	□Yes ZNo
 i. Is the project site located in an Air quality non-attainment area? (Area routinely or periodically fails to meet ambient air quality standards for all or some parts of the year) 	□Yes□No
ii. In addition to emissions as calculated in the application, the project will generate:	
• Tons/year (short tons) of Carbon Dioxide (CO ₂)	
•Tons/year (short tons) of Nitrous Oxide (N2O)	
Tons/year (short tons) of Perfluorocarbons (PFCs)	
•Tons/year (short tons) of Sulfur Hexafluoride (SF ₆)	
 Tons/year (short tons) of Carbon Dioxide equivalent of Hydroflourocarbons (HFCs) 	
 Tons/year (short tons) of Hazardous Air Pollutants (HAPs) 	

h. Will the proposed action generate or emit methane (including, but not limited to, sewage treatment plants,	□Yes 7 No
landfills, composting facilities)?	
If Yes:	
i. Estimate methane generation in tons/year (metric):	nameta baat an
ii. Describe any methane capture, control or elimination measures included in project design (e.g., combustion to ge	nerate neat or
electricity, flaring):	
i. Will the proposed action result in the release of air pollutants from open-air operations or processes, such as	☐Yes Z No
quarry or landfill operations?	
If Yes: Describe operations and nature of emissions (e.g., diesel exhaust, rock particulates/dust):	
: Will the annual action would be analytical in second in the CC as have appeared by all an appearate substantial	DVac Z Na
j. Will the proposed action result in a substantial increase in traffic above present levels or generate substantial	□Yes / No
new demand for transportation facilities or services?	
If Yes: i. When is the peak traffic expected (Check all that apply): ☐ Morning ☐ Evening ☐ Weekend	
Randomly between hours of to ii. For commercial activities only, projected number of truck trips/day and type (e.g., semi trailers and dump trucks)	١.
u. For commercial activities only, projected number of truck trips/day and type (e.g., senii trancis and dump trucks)
iii. Parking spaces: Existing Proposed Net increase/decrease	
iv. Does the proposed action include any shared use parking?	□Yes□No
v. If the proposed action includes any modification of existing roads, creation of new roads or change in existing a	
if the proposed action includes any modification of existing roads, creation of new roads of change in existing	iccess, describe.
vi. Are public/private transportation service(s) or facilities available within ½ mile of the proposed site?	□Yes □ No
vii Will the proposed action include access to public transportation or accommodations for use of hybrid, electric	☐Yes ☐ No
or other alternative fueled vehicles?	
viii. Will the proposed action include plans for pedestrian or bicycle accommodations for connections to existing	☐Yes ☐ No
pedestrian or bicycle routes?	
F	
k. Will the proposed action (for commercial or industrial projects only) generate new or additional demand	☐Yes ✓ No
for energy?	
If Yes:	
i. Estimate annual electricity demand during operation of the proposed action:	
	1
ii. Anticipated sources/suppliers of electricity for the project (e.g., on-site combustion, on-site renewable, via grid/le	ocal utility, or
other):	
w will do to the first the	
iii. Will the proposed action require a new, or an upgrade, to an existing substation?	□Yes□No
l. Hours of operation. Answer all items which apply.	
i. During Construction: ii. During Operations:	
Monday - Friday: 8 hrs Monday - Friday: 24 hr (unmanned)	
Saturday: Saturday: 24 hr (unmanned)	
 Sunday: Holidays: Sunday: Holidays: Holidays: 24 hr (unmanned 	
 Holidays: Holidays: 24 hr (unmanned) 	

If yes: New in the proposed action remove existing natural barriers that could act as a noise barrier or screen?	m. Will the proposed action produce noise that will exceed existing ambient noise levels during construction, operation, or both?	☐ Yes ☑ No
ii. Will the proposed action remove existing natural barriers that could act as a noise barrier or screen?		
Describe: n. Will the proposed action have outdoor lighting? if yes: i. Describe source(s), location(s), height of fixture(s), direction/aim, and proximity to nearest occupied structures: ii. Will proposed action remove existing natural barriers that could act as a light barrier or screen? Describe: o. Does the proposed action have the potential to produce odors for more than one hour per day? If Yes, describe possible sources, potential frequency and duration of odor emissions, and proximity to nearest occupied structures: p. Will the proposed action include any bulk storage of petroleum (combined capacity of over 1,100 gallons) or chemical products 185 gallons in above ground storage or any amount in underground storage? If Yes: i. Product(s) to be stored ii. Volume(s)		
n. Will the proposed action have outdoor lighting? if yes: i. Describe source(s), location(s), height of fixture(s), direction/aim, and proximity to nearest occupied structures: ii. Will proposed action remove existing natural barriers that could act as a light barrier or screen? Describe: O. Does the proposed action have the potential to produce odors for more than one hour per day? If Yes, describe possible sources, potential frequency and duration of odor emissions, and proximity to nearest occupied structures: P. Will the proposed action include any bulk storage of petroleum (combined capacity of over 1,100 gallons) or chemical products 185 gallons in above ground storage or any amount in underground storage? If Yes: I. Product(s) to be stored II. Volume(s) per unit time (e.g., month, year) III. Cenerally, describe the proposed storage facilities: Q. Will the proposed action (commercial, industrial and recreational projects only) use pesticides (i.e., herbicides, insecticides) during construction or operation? If Yes: I. Describe any solid waste(s) to be generated during construction or operation of the facility: Operation:		☐ Yes ☑ No
If yes: i. Describe source(s), location(s), height of fixture(s), direction/aim, and proximity to nearest occupied structures: ii. Will proposed action remove existing natural barriers that could act as a light barrier or screen? □ Yes ☑No Describe: □ O. Does the proposed action have the potential to produce odors for more than one hour per day? If Yes, describe possible sources, potential frequency and duration of odor emissions, and proximity to nearest occupied structures: □ Will the proposed action include any bulk storage of petroleum (combined capacity of over 1,100 gallons) or chemical products 185 gallons in above ground storage or any amount in underground storage? If Yes: i. Product(s) to be stored ii. Volume(s) per unit time (e.g., month, year) iii. Generally, describe the proposed storage facilities: i. Describe proposed action (commercial, industrial and recreational projects only) use pesticides (i.e., herbicides, insecticides) during construction or operation? If Yes: i. Describe proposed action use Integrated Pest Management Practices? ii. Will the proposed action (commercial or industrial projects only) involve or require the management or disposal of solid waste (excluding hazardous materials)? If Yes: i. Describe any solid waste(s) to be generated during construction or operation of the facility: • Construction: tons per (unit of time) • Operation: ii. Describe any proposals for on-site minimization, recycling or reuse of materials to avoid disposal as solid waste: • Construction: • Operation: Operation: Operation:		
ii. Will the proposed action include any bulk storage of petroleum (combined capacity of over 1,100 gallons) or chemical products 185 gallons in above ground storage or any amount in underground storage? If Yes: i. Product(s) to be stored ii. Volume(s) per unit time (e.g., month, year) iii. Generally, describe the proposed action (commercial, industrial and recreational projects only) use pesticides (i.e., herbicides, insecticides) during construction or operation? If Yes: i. Describe any solid waste(s) to be generated during construction or operation of the facility: i. Describe any poposals for on-site minimization, recycling or reuse of materials to avoid disposal as solid waste: Construction: ii. Describe any proposals for on-site minimization, recycling or reuse of materials to avoid disposal as solid waste: Construction: Operation: Operation: Operation: Operation:		☐Yes ZNo
O. Does the proposed action have the potential to produce odors for more than one hour per day? If Yes, describe possible sources, potential frequency and duration of odor emissions, and proximity to nearest occupied structures: p. Will the proposed action include any bulk storage of petroleum (combined capacity of over 1,100 gallons) or chemical products 185 gallons in above ground storage or any amount in underground storage? If Yes: i. Product(s) to be stored ii. Volume(s) per unit time (e.g., month, year) iii. Generally, describe the proposed storage facilities: q. Will the proposed action (commercial, industrial and recreational projects only) use pesticides (i.e., herbicides, insecticides) during construction or operation? If Yes: i. Describe proposed action use Integrated Pest Management Practices? ii. Will the proposed action (commercial or industrial projects only) involve or require the management or disposal of solid waste (excluding hazardous materials)? If Yes: i. Describe any solid waste(s) to be generated during construction or operation of the facility: • Construction: • Operation: tons per (unit of time) • Construction: • Operation:		
If Yes, describe possible sources, potential frequency and duration of odor emissions, and proximity to nearest occupied structures: P. Will the proposed action include any bulk storage of petroleum (combined capacity of over 1,100 gallons) or chemical products 185 gallons in above ground storage or any amount in underground storage? If Yes: I. Product(s) to be stored		☐ Yes ☑ No
or chemical products 185 gallons in above ground storage or any amount in underground storage? If Yes: i. Product(s) to be stored ii. Volume(s) per unit time (e.g., month, year) iii. Generally, describe the proposed storage facilities: q. Will the proposed action (commercial, industrial and recreational projects only) use pesticides (i.e., herbicides, insecticides) during construction or operation? If Yes: i. Describe proposed treatment(s): ii. Will the proposed action use Integrated Pest Management Practices? r. Will the proposed action (commercial or industrial projects only) involve or require the management or disposal of solid waste (excluding hazardous materials)? If Yes: i. Describe any solid waste(s) to be generated during construction or operation of the facility: • Construction: (unit of time) • Operation: (unit of time) ii. Describe any proposals for on-site minimization, recycling or reuse of materials to avoid disposal as solid waste: • Construction: (unit of time)	If Yes, describe possible sources, potential frequency and duration of odor emissions, and proximity to nearest	☐ Yes ☑ No
q. Will the proposed action (commercial, industrial and recreational projects only) use pesticides (i.e., herbicides, insecticides) during construction or operation? If Yes: i. Describe proposed treatment(s): ii. Will the proposed action use Integrated Pest Management Practices? r. Will the proposed action (commercial or industrial projects only) involve or require the management or disposal of solid waste (excluding hazardous materials)? If Yes: i. Describe any solid waste(s) to be generated during construction or operation of the facility: • Construction: tons per (unit of time) • Operation: tons per (unit of time) ii. Describe any proposals for on-site minimization, recycling or reuse of materials to avoid disposal as solid waste: • Operation: Operation: • Operation:	or chemical products 185 gallons in above ground storage or any amount in underground storage? If Yes: i. Product(s) to be stored	☐ Yes ☑ No
insecticides) during construction or operation? If Yes: i. Describe proposed treatment(s): ii. Will the proposed action use Integrated Pest Management Practices? r. Will the proposed action (commercial or industrial projects only) involve or require the management or disposal Yes No of solid waste (excluding hazardous materials)? If Yes: i. Describe any solid waste(s) to be generated during construction or operation of the facility: • Construction:	iii. Generally, describe the proposed storage facilities:	
r. Will the proposed action (commercial or industrial projects only) involve or require the management or disposal of solid waste (excluding hazardous materials)? If Yes: i. Describe any solid waste(s) to be generated during construction or operation of the facility: • Construction:	insecticides) during construction or operation? If Yes:	☐ Yes ☑No
r. Will the proposed action (commercial or industrial projects only) involve or require the management or disposal of solid waste (excluding hazardous materials)? If Yes: i. Describe any solid waste(s) to be generated during construction or operation of the facility: • Construction:		
r. Will the proposed action (commercial or industrial projects only) involve or require the management or disposal of solid waste (excluding hazardous materials)? If Yes: i. Describe any solid waste(s) to be generated during construction or operation of the facility: • Construction: (unit of time) • Operation: (unit of time) ii. Describe any proposals for on-site minimization, recycling or reuse of materials to avoid disposal as solid waste: • Construction: • Operation:	ii Will the proposed action use Integrated Pest Management Practices?	☐ Yes ☑No
 i. Describe any solid waste(s) to be generated during construction or operation of the facility: Construction: tons per (unit of time) Operation: tons per (unit of time) ii. Describe any proposals for on-site minimization, recycling or reuse of materials to avoid disposal as solid waste: Construction: Operation: 	r. Will the proposed action (commercial or industrial projects only) involve or require the management or disposal of solid waste (excluding hazardous materials)?	
 Operation: tons per (unit of time) ii. Describe any proposals for on-site minimization, recycling or reuse of materials to avoid disposal as solid waste: Construction: Operation: 	i. Describe any solid waste(s) to be generated during construction or operation of the facility:	
 ii. Describe any proposals for on-site minimization, recycling or reuse of materials to avoid disposal as solid waste: Construction: Operation: 	• Construction: tons per (unit of time)	
Construction:Operation:	Operation: tons per (unit of time) ## Describe any proposals for on-site minimization, recycling or rause of materials to avoid disposal as solid waster.	
Operation:	Construction:	•
Construction:		
Operation:		

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s. Does the proposed action include construction or modilif Yes:	ification of a solid waste m	anagement facility?	Yes 🗸 No
i. Type of management or handling of waste proposed	for the site (e.g., recycling	or transfer station, composting	, landfill, or
other disposal activities):			
ii. Anticipated rate of disposal/processing:Tons/month, if transfer or other non-	combustion/thermal treatme	ent or	
Tons/hour, if combustion or thermal		ciit, oi	
iii. If landfill, anticipated site life:			
t. Will the proposed action at the site involve the comme	rcial generation, treatment,	storage, or disposal of hazardo	us Yes No
waste?			
If Yes: i. Name(s) of all hazardous wastes or constituents to be	ganarated handled or mar	paged at facility:	
i. I valle (s) of all lazardous wastes of constituents to be	generated, nandied of mar	laged at lacinty.	
ii. Generally describe processes or activities involving h	nazardous wastes or constit	nante:	
u. Generally describe processes of activities involving i	lazardous wastes of collstit	uents.	
iii. Specify amount to be handled or generated to	ons/month		
<i>iv.</i> Describe any proposals for on-site minimization, rec	ycling or reuse of hazardou	is constituents:	
v. Will any hazardous wastes be disposed at an existing	offsite hazardous waste fa	cility?	☐Yes Z No
If Yes: provide name and location of facility:	, onone nazaraous waste na		
If No: describe proposed management of any hazardous	wastes which will not be se	ent to a hazardous waste facility	/:
	THE STATE OF THE S	The to a masar doub master memory	
E. Site and Setting of Proposed Action			
E.1. Land uses on and surrounding the project site			
a. Existing land uses.			
i. Check all uses that occur on, adjoining and near the		1.6	
☐ Urban ☐ Industrial ☐ Commercial ☐ Residence ☐ Forest ☐ Agriculture ☐ Aquatic ☐ Other		ral (non-farm)	
ii. If mix of uses, generally describe:	(specify).		
b. Land uses and covertypes on the project site.			
Land use or	Current	Acreage After	Change
Covertype Roads, buildings, and other paved or impervious	Acreage	Project Completion	(Acres +/-)
surfaces	2.39	2.39	0
Forested			
Meadows, grasslands or brushlands (non- agricultural including chandrand agricultural)	1.42	1.42	0
agricultural, including abandoned agricultural) • Agricultural			
(includes active orchards, field, greenhouse etc.)			
Surface water features			
(lakes, ponds, streams, rivers, etc.)			
Wetlands (freshwater or tidal)			
Non-vegetated (bare rock, earth or fill)			
• Other			
Describe:			

c. Is the project site presently used by members of the community for public recreation? i. If Yes: explain:	□Yes☑No
d. Are there any facilities serving children, the elderly, people with disabilities (e.g., schools, hospitals, licensed day care centers, or group homes) within 1500 feet of the project site? If Yes, i. Identify Facilities:	□Yes ☑ No
e. Does the project site contain an existing dam? If Yes:	☐ Yes No
i. Dimensions of the dam and impoundment:	
Dam height: feet	
• Dam length: feet	
 Surface area: acres Volume impounded: gallons OR acre-feet 	
ii. Dam's existing hazard classification:	
iii. Provide date and summarize results of last inspection:	
f. Has the project site ever been used as a municipal, commercial or industrial solid waste management facility, or does the project site adjoin property which is now, or was at one time, used as a solid waste management facility Yes:	☐Yes Z No lity?
i. Has the facility been formally closed?	☐Yes☐ No
If yes, cite sources/documentation:	
ii. Describe the location of the project site relative to the boundaries of the solid waste management facility:	
iii. Describe any development constraints due to the prior solid waste activities:	
g. Have hazardous wastes been generated, treated and/or disposed of at the site, or does the project site adjoin property which is now or was at one time used to commercially treat, store and/or dispose of hazardous waste? If Yes:	□Yes Z No
i. Describe waste(s) handled and waste management activities, including approximate time when activities occurr	ed:
h. Potential contamination history. Has there been a reported spill at the proposed project site, or have any	☐Yes Z No
remedial actions been conducted at or adjacent to the proposed site? If Yes:	
 i. Is any portion of the site listed on the NYSDEC Spills Incidents database or Environmental Site Remediation database? Check all that apply: 	□Yes□No
☐ Yes – Spills Incidents database Provide DEC ID number(s):	
☐ Yes – Environmental Site Remediation database Provide DEC ID number(s): Neither database	
ii. If site has been subject of RCRA corrective activities, describe control measures:	
iii. Is the project within 2000 feet of any site in the NYSDEC Environmental Site Remediation database? If yes, provide DEC ID number(s):	□Yes☑No
iv. If yes to (i), (ii) or (iii) above, describe current status of site(s):	

v. Is the project site subject to an institutional control limiting property uses?		☐ Yes Z No
If yes, DEC site ID number:		
Describe any use limitations:		
 Describe any engineering controls: Will the project affect the institutional or engineering controls in place? 		□Yes□No
Explain:		L I es LINO
Explain.		
E.2. Natural Resources On or Near Project Site		
a. What is the average depth to bedrock on the project site? N/A existing building	g feet	
b. Are there bedrock outcroppings on the project site?		☐ Yes ✓ No
If Yes, what proportion of the site is comprised of bedrock outcroppings?	%	
c. Predominant soil type(s) present on project site: Urban land	100 %	
c. Predominant soil type(s) present on project site: Urban land	——————————————————————————————————————	
	/0	
d. What is the average depth to the water table on the project site? Average: fe	et .	
	Ct .	Name of the second
e. Drainage status of project site soils: Well Drained: N/A % of site		
Moderately Well Drained: N/A % of site		
Poorly Drained N/A % of site		
f. Approximate proportion of proposed action site with slopes: 💆 0-10%:	100 % of site	
10-15%:	% of site	
15% or greater:	% of site	
g. Are there any unique geologic features on the project site?		☐ Yes ✓ No
If Yes, describe:		
h. Surface water features.		
i. Does any portion of the project site contain wetlands or other waterbodies (including str	eams, rivers,	☐Yes ✓ No
ponds or lakes)?		<u> </u>
ii. Do any wetlands or other waterbodies adjoin the project site?		☐Yes Z No
If Yes to either <i>i</i> or <i>ii</i> , continue. If No, skip to E.2.i.		
iii. Are any of the wetlands or waterbodies within or adjoining the project site regulated by	any federal,	☐ Yes Z No
state or local agency?		
iv. For each identified regulated wetland and waterbody on the project site, provide the following		
	Classification	
Lakes or Ponds: Name Wetlands: Name	Classification Approximate Size	
Wetlands: Name Wetland No. (if regulated by DEC)	Approximate Size	
v. Are any of the above water bodies listed in the most recent compilation of NYS water qu	uality-impaired	☐Yes Z No
waterbodies?		
If yes, name of impaired water body/bodies and basis for listing as impaired:		
i. Is the project site in a designated Floodway?		☐Yes Z No
j. Is the project site in the 100-year Floodplain?		☐Yes Z No
k. Is the project site in the 500-year Floodplain?		☐Yes Z No
l. Is the project site located over, or immediately adjoining, a primary, principal or sole sou	rce aquifer?	☐Yes Z No
If Yes:	roo aquiror:	10301110
i. Name of aquifer:		

n. Does the project site contain a designated significant natural community? If Yes: i. Describe the habitat/community (composition, function, and basis for designation): ii. Source(s) of description or evaluation: iii. Extent of community/habitat: • Currently: • Following completion of project as proposed: • Gain or loss (indicate + or -): • Come project site contain any species of plant or animal that is listed by the federal govern endangered or threatened, or does it contain any areas identified as habitat for an endanger If Yes: i. Species and listing (endangered or threatened): p. Does the project site contain any species of plant or animal that is listed by NYS as rare, or special concern? If Yes: i. Species and listing: p. Does the project site or adjoining area currently used for hunting, trapping, fishing or shell fish If yes, give a brief description of how the proposed action may affect that use: E.3. Designated Public Resources On or Near Project Site a. Is the project site, or any portion of it, located in a designated agricultural district certified Agriculture and Markets Law, Article 25-AA, Section 303 and 304? If Yes, provide county plus district name/number: b. Are agricultural lands consisting of highly productive soils present? i. If Yes: acreage(s) on project site? ii. Source(s) of soil rating(s): c. Does the project site contain all or part of, or is it substantially contiguous to, a registered Natural Landmark? If Yes:	previously disturbed ground.
i. Describe the habitat/community (composition, function, and basis for designation): ii. Source(s) of description or evaluation: iii. Extent of community/habitat: • Currently: • Following completion of project as proposed: • Gain or loss (indicate + or -): • Does project site contain any species of plant or animal that is listed by the federal govern endangered or threatened, or does it contain any areas identified as habitat for an endanger If Yes: i. Species and listing (endangered or threatened): p. Does the project site contain any species of plant or animal that is listed by NYS as rare, or special concern? If Yes: i. Species and listing: q. Is the project site or adjoining area currently used for hunting, trapping, fishing or shell fish If yes, give a brief description of how the proposed action may affect that use: E.3. Designated Public Resources On or Near Project Site a. Is the project site, or any portion of it, located in a designated agricultural district certified Agriculture and Markets Law, Article 25-AA, Section 303 and 304? If Yes, provide county plus district name/number: b. Are agricultural lands consisting of highly productive soils present? i. If Yes: acreage(s) on project site? ii. Source(s) of soil rating(s): c. Does the project site contain all or part of, or is it substantially contiguous to, a registered Natural Landmark?	□Yes Z No
iii. Source(s) of description or evaluation: iii. Extent of community/habitat: • Currently: • Following completion of project as proposed: • Gain or loss (indicate + or -): • Community completion of project as proposed: • Gain or loss (indicate + or -): • Gain or loss (indicate + or -): • Gain or loss (indicate + or -): • Community completion of project as proposed: • Gain or loss (indicate + or -): • Community completion of project of plant or animal that is listed by the federal govern endangered or threatened, or does it contain any areas identified as habitat for an endanger lif Yes: i. Species and listing (endangered or threatened): p. Does the project site contain any species of plant or animal that is listed by NYS as rare, or special concern? If Yes: i. Species and listing: q. Is the project site or adjoining area currently used for hunting, trapping, fishing or shell fish If yes, give a brief description of how the proposed action may affect that use: E.3. Designated Public Resources On or Near Project Site a. Is the project site, or any portion of it, located in a designated agricultural district certified Agriculture and Markets Law, Article 25-AA, Section 303 and 304? If Yes, provide county plus district name/number: b. Are agricultural lands consisting of highly productive soils present? i. If Yes: acreage(s) on project site? ii. Source(s) of soil rating(s): c. Does the project site contain all or part of, or is it substantially contiguous to, a registered Natural Landmark?	
Currently: Following completion of project as proposed: Gain or loss (indicate + or -): Does project site contain any species of plant or animal that is listed by the federal governendangered or threatened, or does it contain any areas identified as habitat for an endanger lifyes: Does the project site contain any species of plant or animal that is listed by NYS as rare, or special concern? If Yes: Does the project site contain any species of plant or animal that is listed by NYS as rare, or special concern? If Yes: Designated Public Resources On or Near Project Site Designated Desig	
• Following completion of project as proposed: • Gain or loss (indicate + or -): o. Does project site contain any species of plant or animal that is listed by the federal govern endangered or threatened, or does it contain any areas identified as habitat for an endanger If Yes: i. Species and listing (endangered or threatened): p. Does the project site contain any species of plant or animal that is listed by NYS as rare, or special concern? If Yes: i. Species and listing: q. Is the project site or adjoining area currently used for hunting, trapping, fishing or shell fish If yes, give a brief description of how the proposed action may affect that use: E.3. Designated Public Resources On or Near Project Site a. Is the project site, or any portion of it, located in a designated agricultural district certified Agriculture and Markets Law, Article 25-AA, Section 303 and 304? If Yes, provide county plus district name/number: b. Are agricultural lands consisting of highly productive soils present? i. If Yes: acreage(s) on project site? ii. Source(s) of soil rating(s): c. Does the project site contain all or part of, or is it substantially contiguous to, a registered Natural Landmark?	
• Gain or loss (indicate + or -):	
endangered or threatened, or does it contain any areas identified as habitat for an endanger If Yes: i. Species and listing (endangered or threatened): c. Does the project site contain any species of plant or animal that is listed by NYS as rare, or special concern? If Yes: i. Species and listing: G. Is the project site or adjoining area currently used for hunting, trapping, fishing or shell fish figures, give a brief description of how the proposed action may affect that use: E.3. Designated Public Resources On or Near Project Site a. Is the project site, or any portion of it, located in a designated agricultural district certified Agriculture and Markets Law, Article 25-AA, Section 303 and 304? If Yes, provide county plus district name/number: c. Are agricultural lands consisting of highly productive soils present? i. If Yes: acreage(s) on project site? ii. Source(s) of soil rating(s): c. Does the project site contain all or part of, or is it substantially contiguous to, a registered Natural Landmark?	
special concern? If Yes: i. Species and listing: q. Is the project site or adjoining area currently used for hunting, trapping, fishing or shell fish yes, give a brief description of how the proposed action may affect that use: E.3. Designated Public Resources On or Near Project Site a. Is the project site, or any portion of it, located in a designated agricultural district certified Agriculture and Markets Law, Article 25-AA, Section 303 and 304? If Yes, provide county plus district name/number: b. Are agricultural lands consisting of highly productive soils present? i. If Yes: acreage(s) on project site? ii. Source(s) of soil rating(s): c. Does the project site contain all or part of, or is it substantially contiguous to, a registered Natural Landmark?	red or threatened species?
q. Is the project site or adjoining area currently used for hunting, trapping, fishing or shell fish figures, give a brief description of how the proposed action may affect that use: E.3. Designated Public Resources On or Near Project Site a. Is the project site, or any portion of it, located in a designated agricultural district certified Agriculture and Markets Law, Article 25-AA, Section 303 and 304? If Yes, provide county plus district name/number: b. Are agricultural lands consisting of highly productive soils present? i. If Yes: acreage(s) on project site? ii. Source(s) of soil rating(s): c. Does the project site contain all or part of, or is it substantially contiguous to, a registered Natural Landmark?	
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Agriculture and Markets Law, Article 25-AA, Section 303 and 304? If Yes, provide county plus district name/number: b. Are agricultural lands consisting of highly productive soils present? i. If Yes: acreage(s) on project site? ii. Source(s) of soil rating(s): c. Does the project site contain all or part of, or is it substantially contiguous to, a registered Natural Landmark?	
 i. If Yes: acreage(s) on project site? ii. Source(s) of soil rating(s): c. Does the project site contain all or part of, or is it substantially contiguous to, a registered Natural Landmark? 	
c. Does the project site contain all or part of, or is it substantially contiguous to, a registered Natural Landmark?	∐Yes ☑No
 i. Nature of the natural landmark:	Feature
d. Is the project site located in or does it adjoin a state listed Critical Environmental Area? If Yes: i. CEA name: ii. Basis for designation:	
ii. Basis for designation:	

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e. Does the project site contain, or is it substantially contiguous to, a building, archaeological site, or district which is listed on the National or State Register of Historic Places, or that has been determined by the Commission Office of Parks, Recreation and Historic Preservation to be eligible for listing on the State Register of Historic Place If Yes:	
 i. Nature of historic/archaeological resource: Archaeological Site Historic Building or District ii. Name: Eligible property: Catholic Charities of Onondaga County and the Toomey Residential and Community Services 	
iii. Brief description of attributes on which listing is based: Architecture and Social History	
f. Is the project site, or any portion of it, located in or adjacent to an area designated as sensitive for archaeological sites on the NY State Historic Preservation Office (SHPO) archaeological site inventory?	□Yes ☑ No
If Yes:	□Yes ☑ No
i. Describe possible resource(s):	
h. Is the project site within fives miles of any officially designated and publicly accessible federal, state, or local scenic or aesthetic resource? If Yes:	∠ Yes □ No
 i. Identify resource: Onondaga Lake ii. Nature of, or basis for, designation (e.g., established highway overlook, state or local park, state historic trail or so etc.): Scenic 	cenic byway,
iii. Distance between project and resource:	
 i. Is the project site located within a designated river corridor under the Wild, Scenic and Recreational Rivers Program 6 NYCRR 666? If Yes: i. Identify the name of the river and its designation: 	☐ Yes No
	□Yes □No
F. Additional Information Attach any additional information which may be needed to clarify your project. If you have identified any adverse impacts which could be associated with your proposal, please describe those imp measures which you propose to avoid or minimize them.	eacts plus any
G. VerificationI certify that the information provided is true to the best of my knowledge.	
Applicant/Sponsor Name Nova Group, GBC Date 9/28/2021	
Signature Title_Project Manager - Biologist	

PRINT FORM



Disclaimer: The EAF Mapper is a screening tool intended to assist project sponsors and reviewing agencies in preparing an environmental assessment form (EAF). Not all questions asked in the EAF are answered by the EAF Mapper. Additional information on any EAF question can be obtained by consulting the EAF Workbooks. Although the EAF Mapper provides the most up-to-date digital data available to DEC, you may also need to contact local or other data sources in order to obtain data not provided by the Mapper. Digital data is not a substitute for agency determinations.



ston@penStreetMap contributors, and the GIS User Community

B.i.i [Coastal or Waterfront Area]	No
B.i.ii [Local Waterfront Revitalization Area]	No
C.2.b. [Special Planning District]	Digital mapping data are not available or are incomplete. Refer to EAF Workbook.
E.1.h [DEC Spills or Remediation Site - Potential Contamination History]	Digital mapping data are not available or are incomplete. Refer to EAF Workbook.
E.1.h.i [DEC Spills or Remediation Site - Listed]	Digital mapping data are not available or are incomplete. Refer to EAF Workbook.
E.1.h.i [DEC Spills or Remediation Site - Environmental Site Remediation Database]	Digital mapping data are not available or are incomplete. Refer to EAF Workbook.
E.1.h.iii [Within 2,000' of DEC Remediation Site]	No
E.2.g [Unique Geologic Features]	No
E.2.h.i [Surface Water Features]	No
E.2.h.ii [Surface Water Features]	No
E.2.h.iii [Surface Water Features]	No
E.2.h.v [Impaired Water Bodies]	No
E.2.i. [Floodway]	No
E.2.j. [100 Year Floodplain]	No
E.2.k. [500 Year Floodplain]	No
E.2.I. [Aquifers]	No
E.2.n. [Natural Communities]	No
E.2.o. [Endangered or Threatened Species]	No
E.2.p. [Rare Plants or Animals]	No
E.3.a. [Agricultural District]	No

E.3.c. [National Natural Landmark]	No
E.3.d [Critical Environmental Area]	No
	Yes - Digital mapping data for archaeological site boundaries are not available. Refer to EAF Workbook.
E.3.e.ii [National or State Register of Historic Places or State Eligible Sites - Name]	Eligible property:Catholic Charities of Onondaga County and the Toomey Residential and Community Services
E.3.f. [Archeological Sites]	No
E.3.i. [Designated River Corridor]	No



